ORAN PARK LEISURE CENTRE

CIVIL WORKS

GENERAL NOTES

- 1. Contractor must verify all dimensions and existing levels on site prior to commencement of works. Any discrepancies to be reported to the
- 2. Strip all topsoil from the construction area. All stripped topsoil shall be disposed of off-site unless directed otherwise. 3. Make smooth connection with all existing works.
- 4. Compact subgrade under buildings and pavements to minimum 98% standard maximum dry density in accordance with AS 1289 5.1.1. Compaction under buildings to extend 2m minimum beyond building
- 5. All work on public property, property which is to become public property, or any work which is to come under the control of the Statutory Authority; the Contractor is to ensure that the drawings used for construction have been approved by all relevant
- authorities prior to commencement site. 6. All work on public property, property which is to become public property, or any work which is to come under the control of the Statutory Authority is to be carried out in accordance with the requirements of the relevant Authority. The Contractor shall obtain these requirements from the Authority. Where the requirements of the Authority are different to the drawings and specifications, the requirements of the Authority shall be applicable.
- 7. For all temporary batters refer to geotechnical recommendations.

REFERENCE DRAWINGS

1. These drawings have been based from, and to be read in conjunction with the following Consultants drawings. Any conflict to the drawings must be notified immediately to the Engineer.

Consultant	Dwg Title	Dwg No	Rev	Date
WARREN AND MAHONEY	LOWER GROUND FLOOR	A10.001	-	08.06.2
WARREN AND MAHONEY		A10.002	-	08.06.2
JOHN LOWE AND ASS.	DETAIL SURVEY	99091	-	24.04.20
JMD DESIGN	LANDSCAPE	_	-	01.06.2

SURVEY AND SERVICES INFORMATION

Origin of levels Datum of levels : AHD

Coordinate system : MGA GDA94 Survey prepared by: JOHN LOWE AND ASSOCIATES Setout Points : SSM 193408

Taylor Thomson Whitting does not guarantee that the survey information shown on these drawings is accurate and will accept no liability for any inaccuracies in the survey information provided to us from any cause whatsoever.

UNDERGROUND SERVICES - WARNING

The locations of underground services shown on Taylor Thomson Whittings drawings have been plotted from diagrams provided by service authorities. This information has been prepared solely for the authorities own use and may not necessarily be updated or accurate.

The position of services as recorded by the authority at the time of installation may not reflect changes in the physical environment subsequent to installation.

Taylor Thomson Whitting does not guarantee that the services information shown on these drawings shows more than the presence or absence of services, and will accept no liability for inaccuracies in the services information shown from any cause whatsoever.

The Contractor must confirm the exact location and extent of services prior to construction and notify any conflict with the drawings immediately to the Engineer/Superintendent.

The contractor is to get approval from the relevant state survey department, to remove/adjust any survey mark. This includes but is not limited to; State Survey Marks (SSM), Permanent Marks (PM), cadastral reference marks or any other survey mark which is to be removed or adjusted in any way.

Taylor Thomson Whitting plans do not indicate the presence of any survey mark. The contractor is to undertake their own search.

BOUNDARY AND EASEMENT NOTE The property boundary and easement locations shown on Taylor

Thomson Whitting drawing's have been based from information

easement information shown is correct. Taylor Thomson Whitting will accept no liabilities for boundary inaccuracies. The contractor/builder is advised to check/confirm all boundaries in relation to all proposed work prior to the commencement of construction. Boundary inaccuracies found are to be reported to the superintendent prior to construction starting.

Taylor Thomson Whitting makes no guarantees that the boundary or

KERBING NOTES

Includes all kerbs, gutters, dish drains, crossings and edges.

1. All kerbs, gutters, dish drains and crossings to be constructed on minimum 75mm granular basecourse compacted to minimum 98% modified maximum dry density in accordance with AS 1289 5.2.1. 2. Expansion joints (EJ) to be formed from 10mm compressible cork

filler board for the full depth of the section and cut to profile. Expansion joints to be located at drainage pits, on tangent points of curves and elsewhere at 12m centres except for integral kerbs where the expansion joints are to match the joint locations in slabs 3. Weakened plane joints to be min 3mm wide and located at 3m centres except for integral kerbs where weakened plane joints are t

match the joint locations in slabs. 4. Broomed finished to all ramped and vehicular crossings, all other kerbing or dish drains to be steel float finished.

5. In the replacement of kerbs -Existing road pavement is to be sawcut 900mm from lip of gutter. Upon completion of new kerbs, new basecourse and surface is to be laid 900mm wide to match existing materials and thicknesses.

Existing allotment drainage pipes are to be built into the new kerb with a 100mm dia hole. Existing kerbs are to be completely removed where new kerbs

SIGNS AND LINE MARKING NOTES

accordance with the requirements of the relevant Road Authority. The contractor shall obtain these requirements from the Road

1. Pavement marking and sign posting on public roads shall be in

1. Pavement marking and sign posting to be in accordance with R.T.A. 'Interim Guide to Signs and Markings' 2. Contractor is to provide guide posts, spaced in accordance with AS1742.2. They are to be located near all head walls and pipe

3. Raised pavement markers to be in accordance with AS1742.2 4. Where existing pavement marking conflicts with proposed, it is to

5. Lane widths do not include width of gutter. 6. Line marking plan does not define boundaries.

7. Erect temporary sign 'changed traffic conditions ahead' 120m ahead of new work in both directions. 8. Establish the location of existing utility services and locate new

signs clear of these installations. 9. The sloped face of the SF median kerbs which adjoin through lanes, are to be painted white in lieu of an E3 edge line. The reflective pavement markers normally associated with an E3 edge line are to be located on the pavement adjacent to the SF kerb.

10. Bicycle pavement markings and sign posting to be in accordance with Austroads Standards. 1. The design of major directional sign posting to be prepared and

STORMWATER DRAINAGE NOTES

Stormwater Design Criteria

assessed by the R.T.A.

(A) Average exceedance probability 1% AEP for roof drainage to first external pit 5% AEP for paved and landscaped areas (B) Rainfall intensities -Time of concentration: 5 minutes 1% AEP = 247 mm/hr

5% AEP = 163 mm/hr(C) Rainfall losses -Impervious areas: IL = 1.5 mm, CL = 0 mm/hrPervious areas: IL = 38.0 mm . CL = 3.7 mm/hr

2. Pipes 300 dia and larger to be reinforced concrete Class "2" approved spigot and socket with rubber ring joints U.N.O. 3. Pipes up to 300 dia shall be sewer grade uPVC with solvent

4. Equivalent strength VCP or FRP pipes may be used subject to approval.

5. Precast pits may be used external to the building subject to approval by Engineer . Enlargers, connections and junctions to be manufactured

fittings where pipes are less than 300 dia. . Where subsoil drains pass under floor slabs and vehicular pavements, unslotted uPVC sewer grade pipe is to be used. 3. Grates and covers shall conform with AS 3996—2006. and

AS 1428.1 for access requirements. 9. Pipes are to be installed in accordance with AS 3725. All

bedding to be type H2 U.N.O. 10. Care is to be taken with levels of stormwater lines. Grades shown are not to be reduced without approval.

. All stormwater pipes to be 150 dia at 1.0% min fall U.N.O. 2. Subsoil drains to be slotted flexible uPVC U.N.O. 13. Adopt invert levels for pipe installation (grades shown are

only nominal).

shall be submitted to Engineer for review. No holes or chases shall be made in the slab without the approval

Conduits and pipes are to be fixed to the underside of the top reinforcement layer. 8. Slurry used to lubricate concrete pump lines is not to be used in

> any structural members. 9. All´slabs cast on ground require sand blinding with a Concrete

The design, certification, construction and performance of the formwork, falsework and backpropping shall be the responsibility of the contractor. Proposed method of installation and removal of formwork is to be submitted to the superintendent for comment prior to work being carried out.

SITEWORKS NOTES

FORMWORK

CONCRETE NOTES

directed in the Specification.

Architects drawings and specifications.

as defined in AS 1379.

EXPOSURE CLASSIFICATION: External: B2

Use Type 'GP' cement, unless otherwise specified.

Place concrete of the following characteristic compressive strength f'c

All concrete shall be subject to project assessment and testing to

Consolidate by mechanical vibration. Cure all concrete surfaces as

6. Unless shown on the drawings, the location of all construction joints

4. For all falls in slab, drip grooves, reglets, chamfers etc. refer to

AS 1379 f'c MPa Specified Nominal Agg. Size

- 1. All basecourse material to comply with RMS specification No 3051 and compacted to minimum 98% modified standard dry density in accordance with AS 1289 5.2.1.
- 2. All trench backfill material shall be compacted to the same density as the adjacent material. 3. All service trenches under vehicular pavements shall be backfilled with an approved select material and compacted to a minimum

98% standard maximum dry density in accordance with AS 1289 5.1.1 PIT SCHEDULE

Note: Grate size does not necessarily reflect pit size, refer pit type details, shown on detail sheets - C51 Final internal pit dimensions are to comply with AS3500

		ammonomo amb to tompi, mini mossi	u.				
Type	Description	Cover (Clear Opening)	Number				
A	Surface inlet pit	900 x 900 Class D galvanised mild steel grate hinged to frame	1-6,22, 27-32				
,,	Junction pit	900 x 900 Class D cast iron cover with concrete infill	7, 23–26				
В	Surface inlet pit	600 x 600 Class D galvanised mild steel grate hinged to frame	8-21				
n/a	Pit insert	n/a	1,3,5,6,27 32				
С	Oil Separator	n/a	33				

SAFETY IN DESIGN

Contractor to refer to Appendix B of the Civil Specification for the Civil Risk and Solutions Register.

EXISTING SERVICES

Contractor to be aware existing services are located within the site. Location of all services to be verified by the Contractor prior to commencing works. Contractor to confirm with relevant authority regarding measures to be taken to ensure services are protected or procedures are in place to demolish and/or relocate.

EXISTING STRUCTURES

Contractor to be aware existing structures may exist within the site. To prevent damage to existing structure(s) and/or personnel, site works to be carried out as far as practicably possible from existing

EXISTING TREES

Contractor to be aware existing trees exist within the site which need to be protected. To prevent damage to trees and/or personnel, site works to be carried out as far as practicably possible from existing trees. Advice needs to be sought from Arborist and/or Landscape Architect on measures required to protect trees.

Contractor to be aware ground water levels are close to existing surface level. Temporary de-watering may be required during construction works.

Deep excavations due to stormwater drainage works is required. Contractor to ensure safe working procedures are in place for works. All excavations to be fenced off and batters adequately supported to approval of Geotechnical Engineer. **GROUND CONDITIONS**

Contractor to be aware of the site geotechnical conditions. Refer to geotechnical report by JKGeotecnics 33260Arpt Rev1 for details.

HAZARDOUS MATERIALS

Existing asbestos products & contaminated material may be present on site. Contractor to ensure all hazardous materials are identified prior to commencing works. Safe working practices as per relevant authority to be adopted and appropriate PPE to be used when handling all hazardous materials. Refer to geotechnical/environmental report by JKGeotecnics 33260Arpt Rev1 for details.

CONFINED SPACES

Contractor to be aware of potential hazards due to working i confined spaces such as stormwater pits, trenches and/or tanks. Contractor to provide safe working methods and use appropriate PPE when entering confined spaces.

MANUAL HANDLING

Contractor to be aware manual handling may be required during construction. Contractor to take appropriate measures to ensure manual handling procedures and assessments are in place prior to commencing

WATER POLLUTION

Contractor to ensure appropriate measures are taken to prevent pollutants from construction works contaminating the surrounding environment.

SITE ACCESS/EGRESS

Contractor to be aware site works occur in close proximity to footpaths and roadways. Contractor to erect appropriate barriers and signage to protect site personnel and public.


VEHICLE MOVEMENT

Contractor to supply and comply with traffic management plan and provide adequate site traffic control including a certified traffic marshall to supervise vehicle movements where necessary.

SITEWORKS LEGEND


Finished surface level

and line with

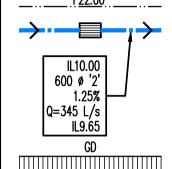

Invert level upstream Pipe size and class Pipe grade Flow (Litres per second) Invert level downstream

Stormwater pit, flow direction

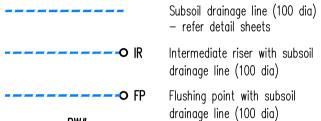

Intermediate riser with subsoil drainage line (100 dia) Flushing point with subsoil drainage line (100 dia)

PAVEMENT LEGEND

Refer to Landscape Plan for Landscape finishes

JOINTING NOTES

- **Vehicular Pavement Jointing** 1. All vehicular pavements to be jointed as shown on drawings. 2. Keyed construction joints should generally be located at a
- maximum of 6m centres. 5. Sawn joints should generally be located at a maximum of 6m centres or 1.5 x the spacing of keyed joints, where key joint spacing is less than 4m, with dowelled expansion joints at
- maximum of 30m centres. 4. Provide 10mm wide full depth expansion joints between buildings and all concrete or unit pavers.
- 5. The timing of the saw cut is to be confirmed by the contractor on site. Site conditions will determine how many hours after the concrete pour before the saw cuts are commenced. Refer to the specification for weather conditions and temperatures required.


0.	venicular	pavemen	t jointing	as tollow	S.		
			FACE	0 F	KERE		
S	DEJA DEJ	SJ	l'S	 75	İ	- <u>55</u> -	- PS
		6m MAX			6m MAX		
	DEJA				త్ర్		
				30m MAX			
	DEJA						
					! 		
	EJ	FA	CE 0	F B L	ILDI	N G	

Pedestrian Footpath Jointing

1. Expansion joints are to be located where possible at tangent points of curves and elsewhere at max 6.0m centres. ?. Weakened plane joints are to be located at a max 1.5 x width of the payement.

3. Where possible joints should be located to match kerbing and / or

adjacent pavement joints. 4. All pedestrian footpath jointings as follows (uno).

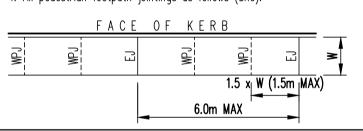



SITE LOCALITY PLAN

DRAWING SCHEDULE **Drawing No Drawing Title NOTES AND LEGENDS SHEET** C03 **DBYD PLAN** C10 **EXISTING SURFACE LEVEL** C11 **EXISTING SHALE SURFACE LEVELS** PROPOSED SITE STRIP LEVELS C12 C14 PROPOSED CUT & FILL LEVELS C21 SEDIMENT AND EROSION CONTROL PLAN C31 PROPOSED SITEWORKS PLAN-LOWER GROUND C32 PROPOSED SITWORKS PLAN-GROUND FLOOR C41 **SECTIONS SHEET** C51 **DETAILS SHEET-1** C52 **DETAILS SHEET-2 OSD TANK DETAIL**

PRELIMINARY NOT TO BE USED FOR CONSTRUCTION

WARREN AND MAHONEY Suite 13.03, Plaza Building 95 Pitt Street Sydney NSW 2000 P2 PRELIMINARY DM NS 06.08.21 Australia P1 ISSUE FOR DA DM SH 11.06.21 +61 2 8021 9809 Eng Draft Date Rev Description Eng Draft Date Rev Description australia@warrenandmahonev.com Rev Description





ORAN PARK LEISURE CENTRE


NOTES & LEGENDS SHEET


NTS NS 191905

Plot File Created: Aug 06, 2021 - 4:39pm

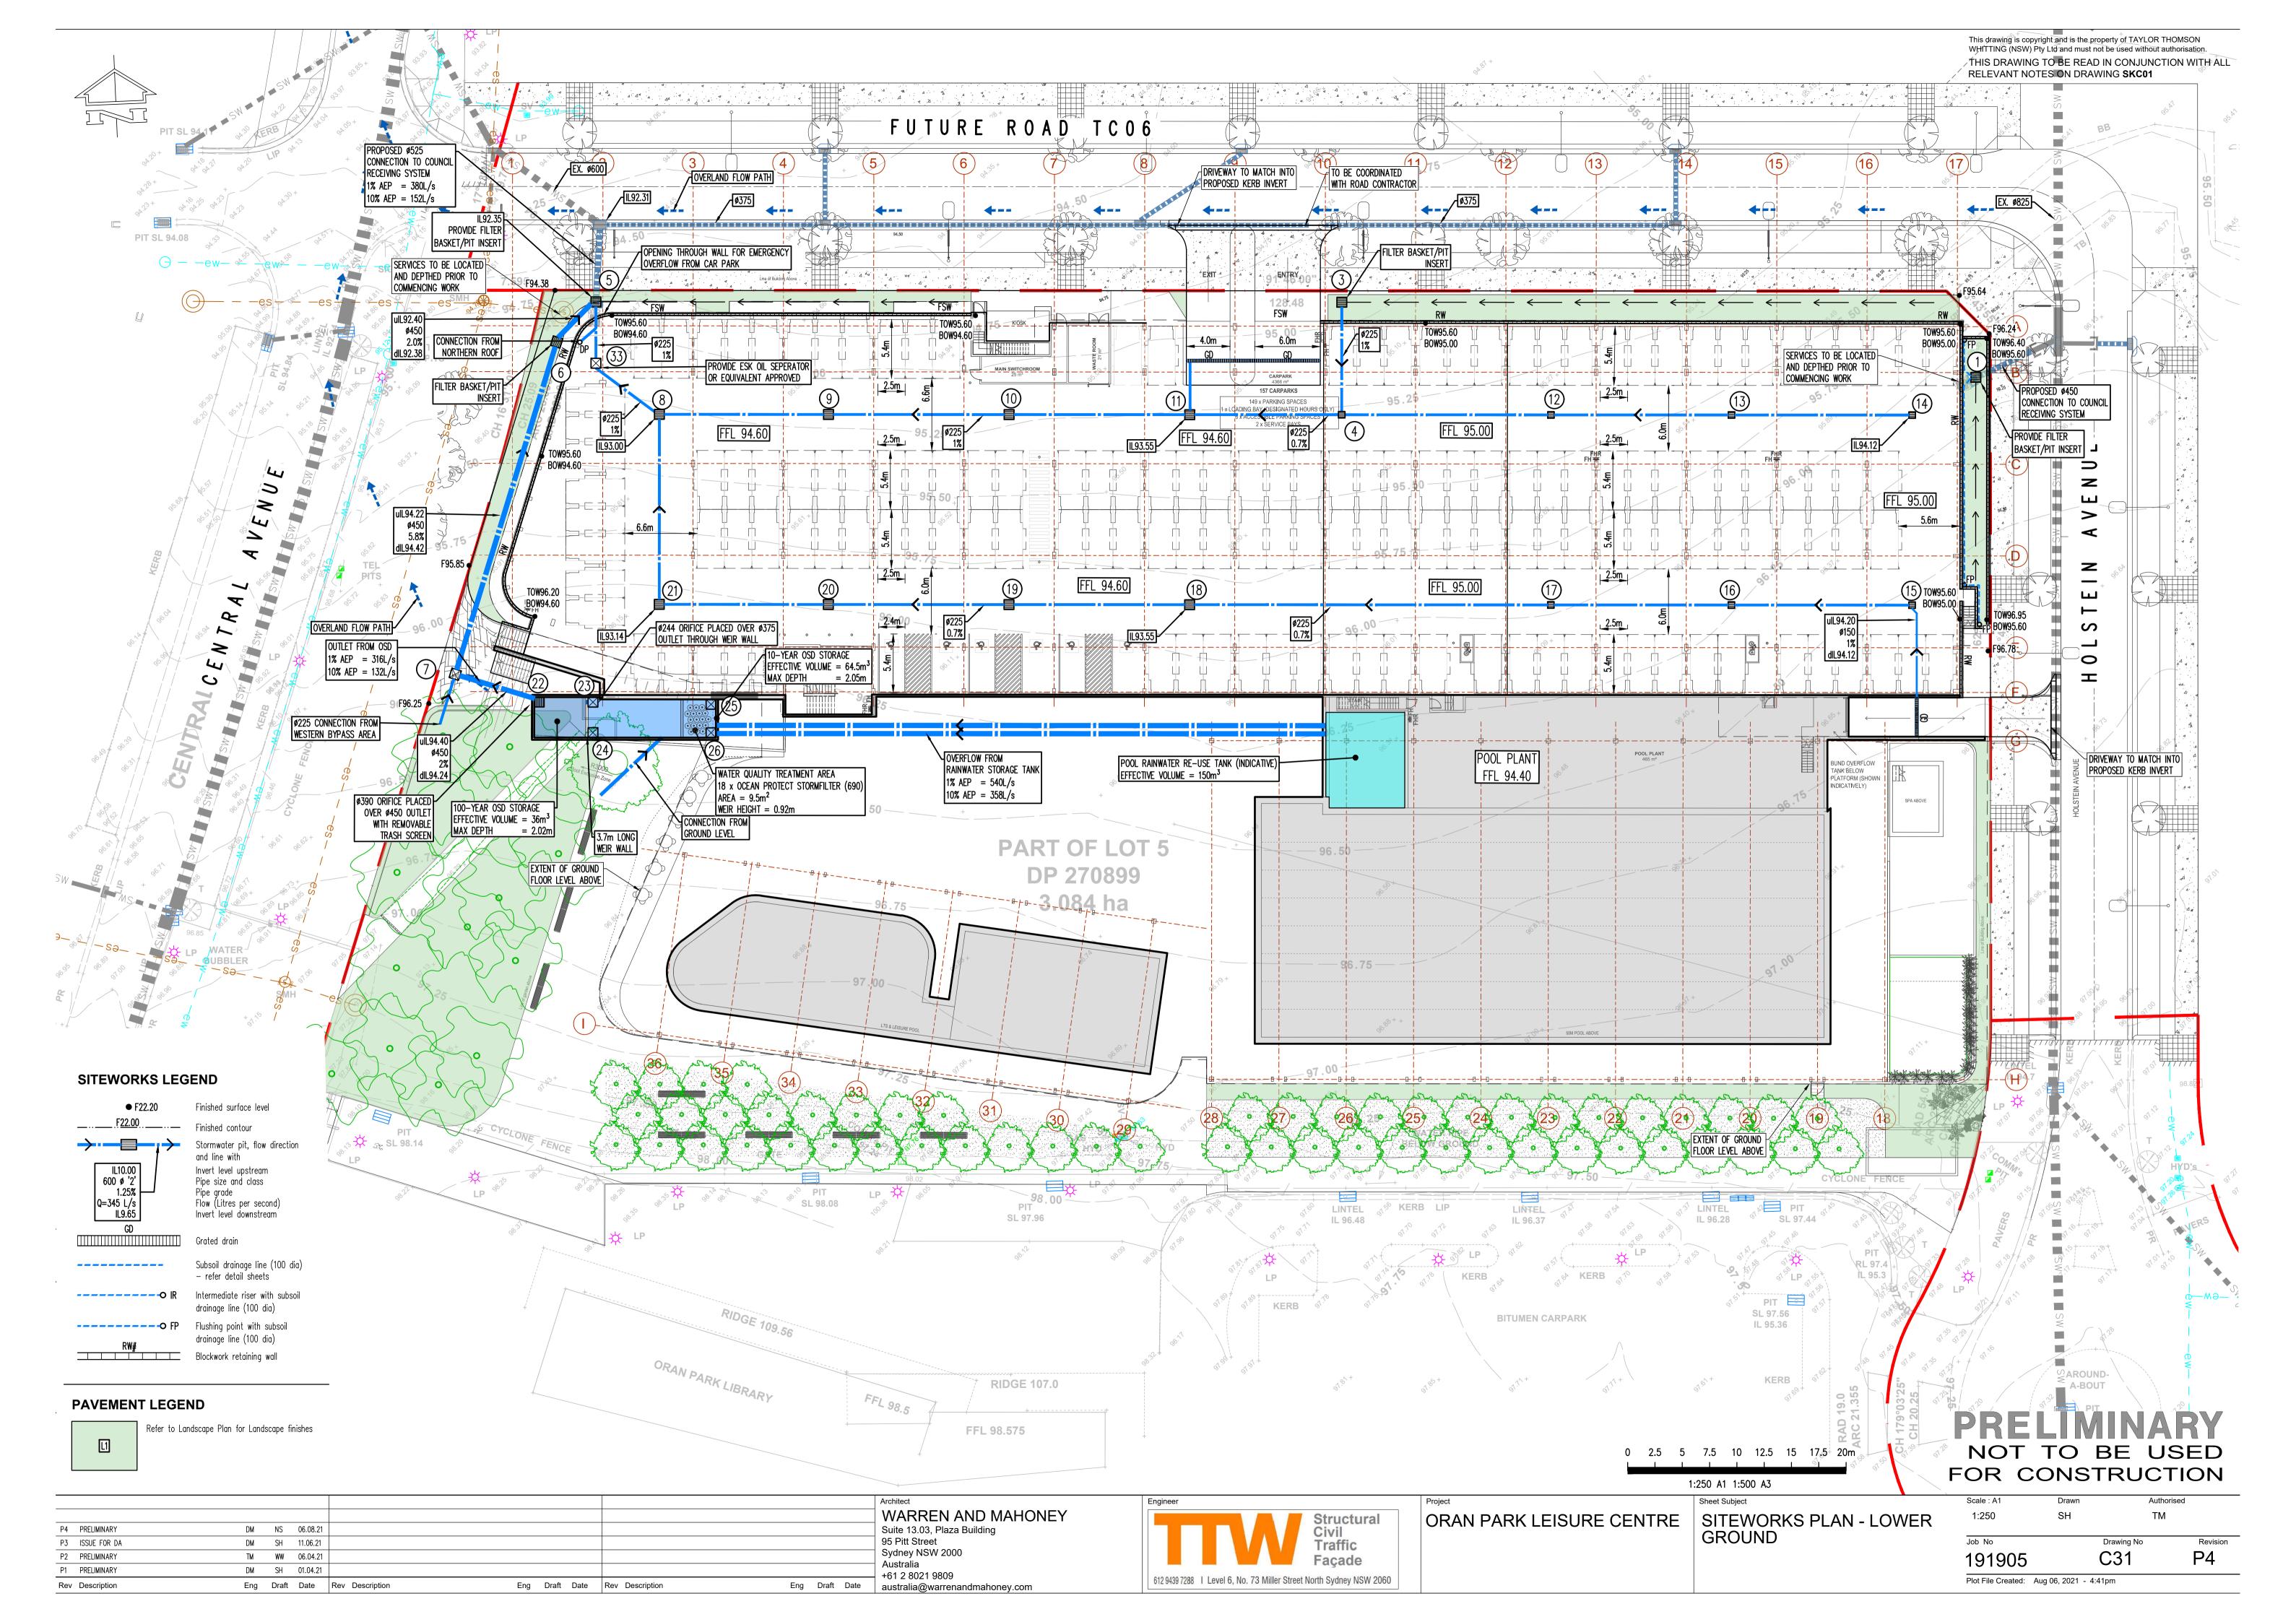

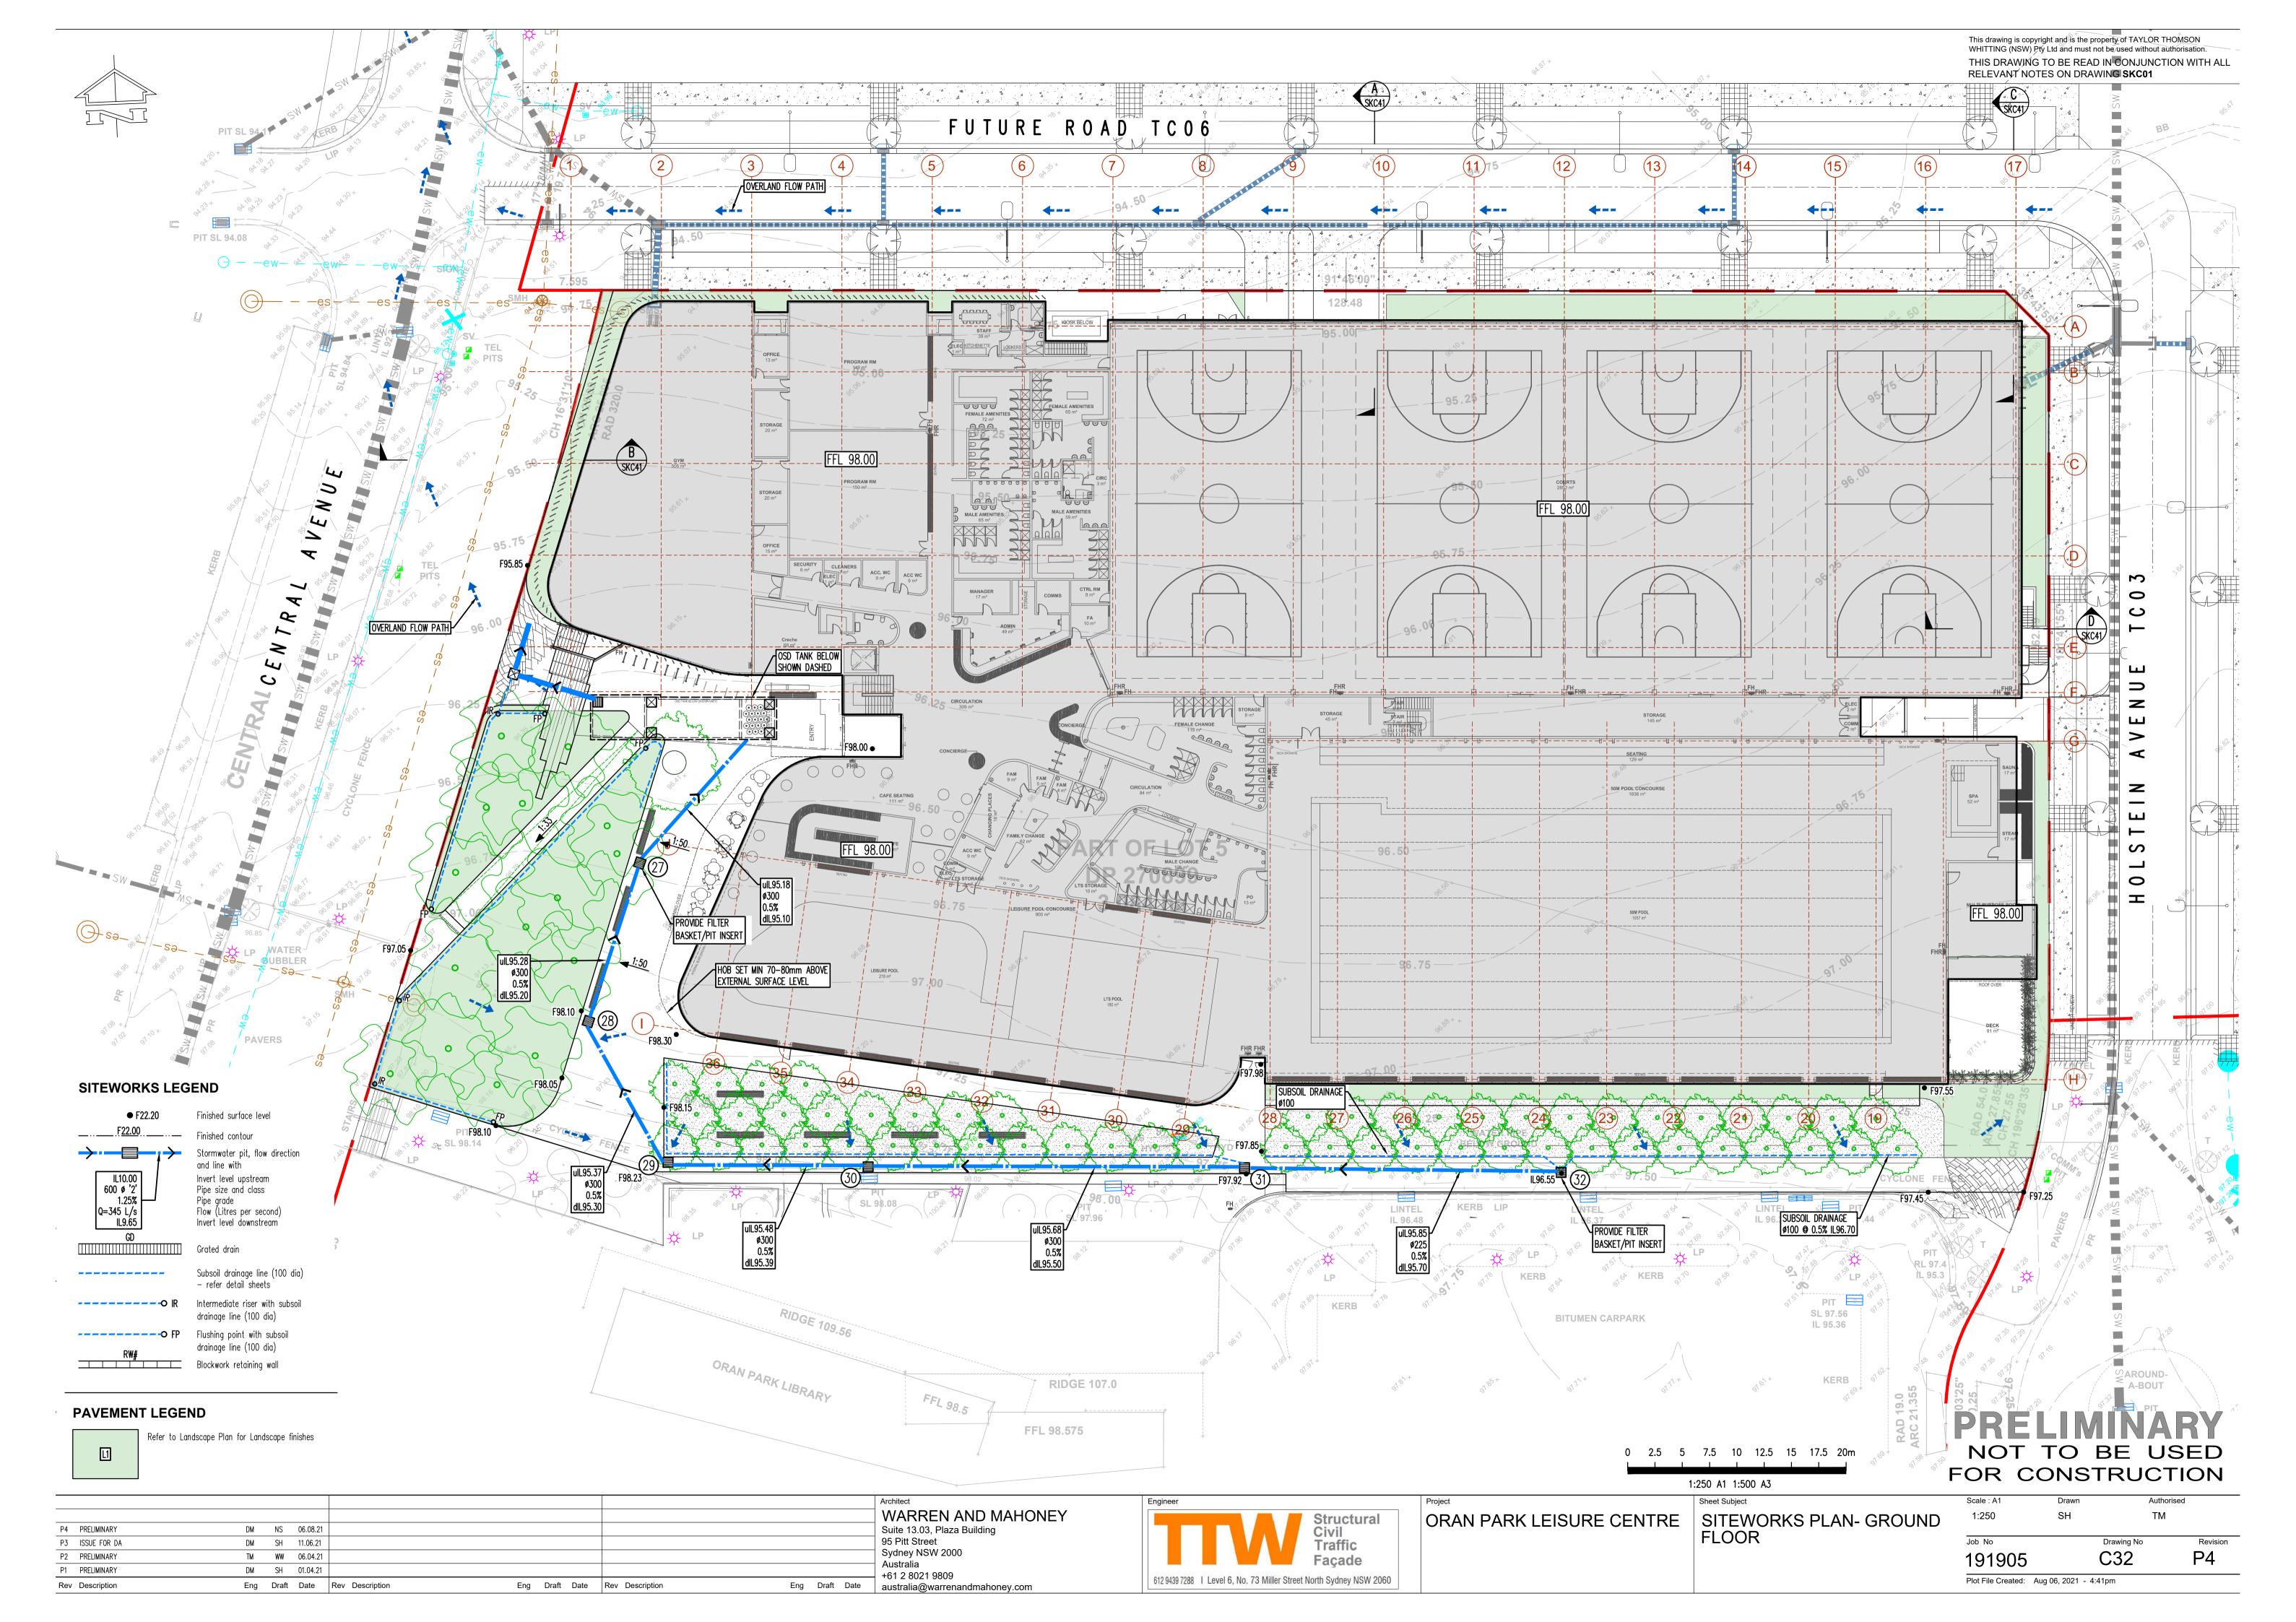

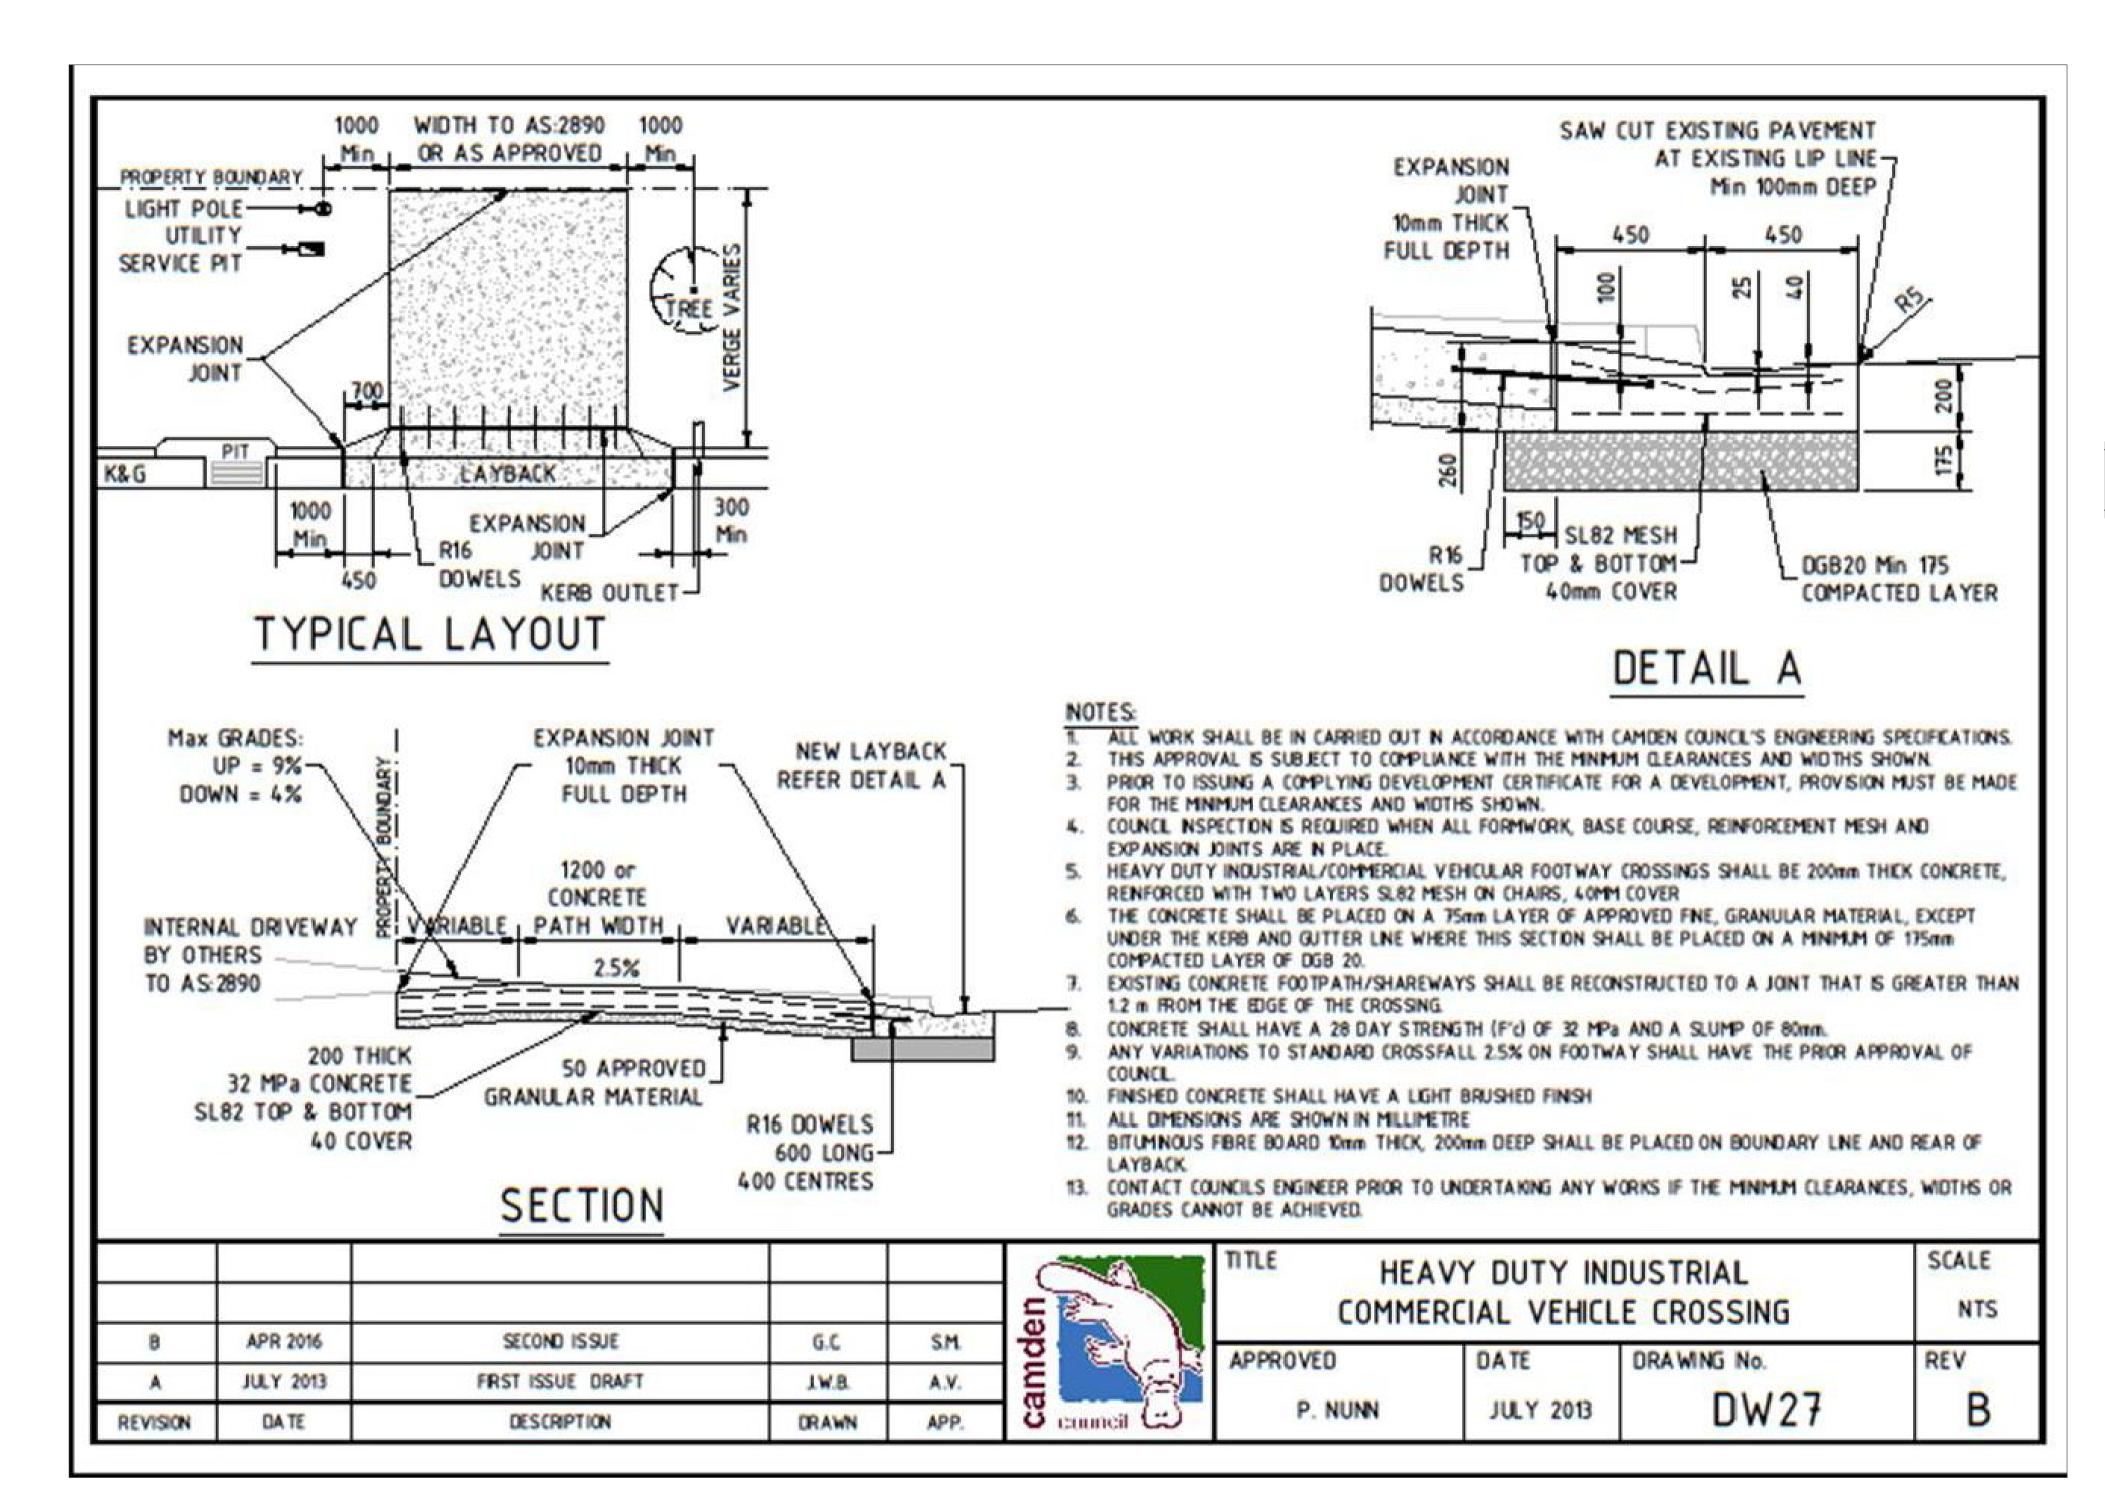

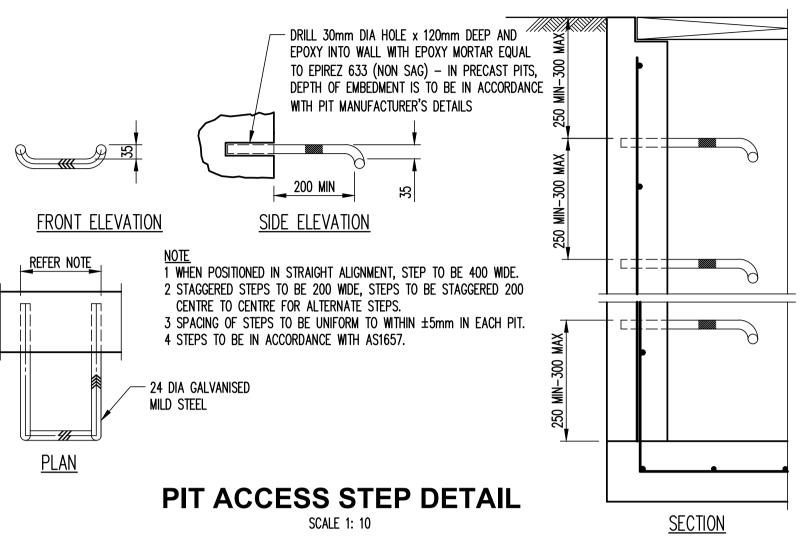

PRELIMINARY NOT TO BE USED FOR CONSTRUCTION


												Architect WARREN AND MAHONEY Suite 13.03, Plaza Building 95 Pitt Street
PRELIMINARY D	DM	NS	06.08.21									Sydney NSW 2000
ISSUE FOR DA D	M	SH	11.06.21									Australia +61 2 8021 9809
Description E	ing [Oraft	Date	Rev Description	Eng	Draft	Date	Rev Description	Eng	Draft	Date	australia@warrenandmahoney.com





	•
	ORAN PARK LEISURE CENTRE

Sheet Subject	
DETAILS SHEET 2	

Scale : A1	Drawn	Author	ised
AS SHOWN	SH	SB	
Job No	Г	Drawing No	Revision
191905		C52	P2
Plot File Created:	Aug 06, 2021 - 4:41	pm	

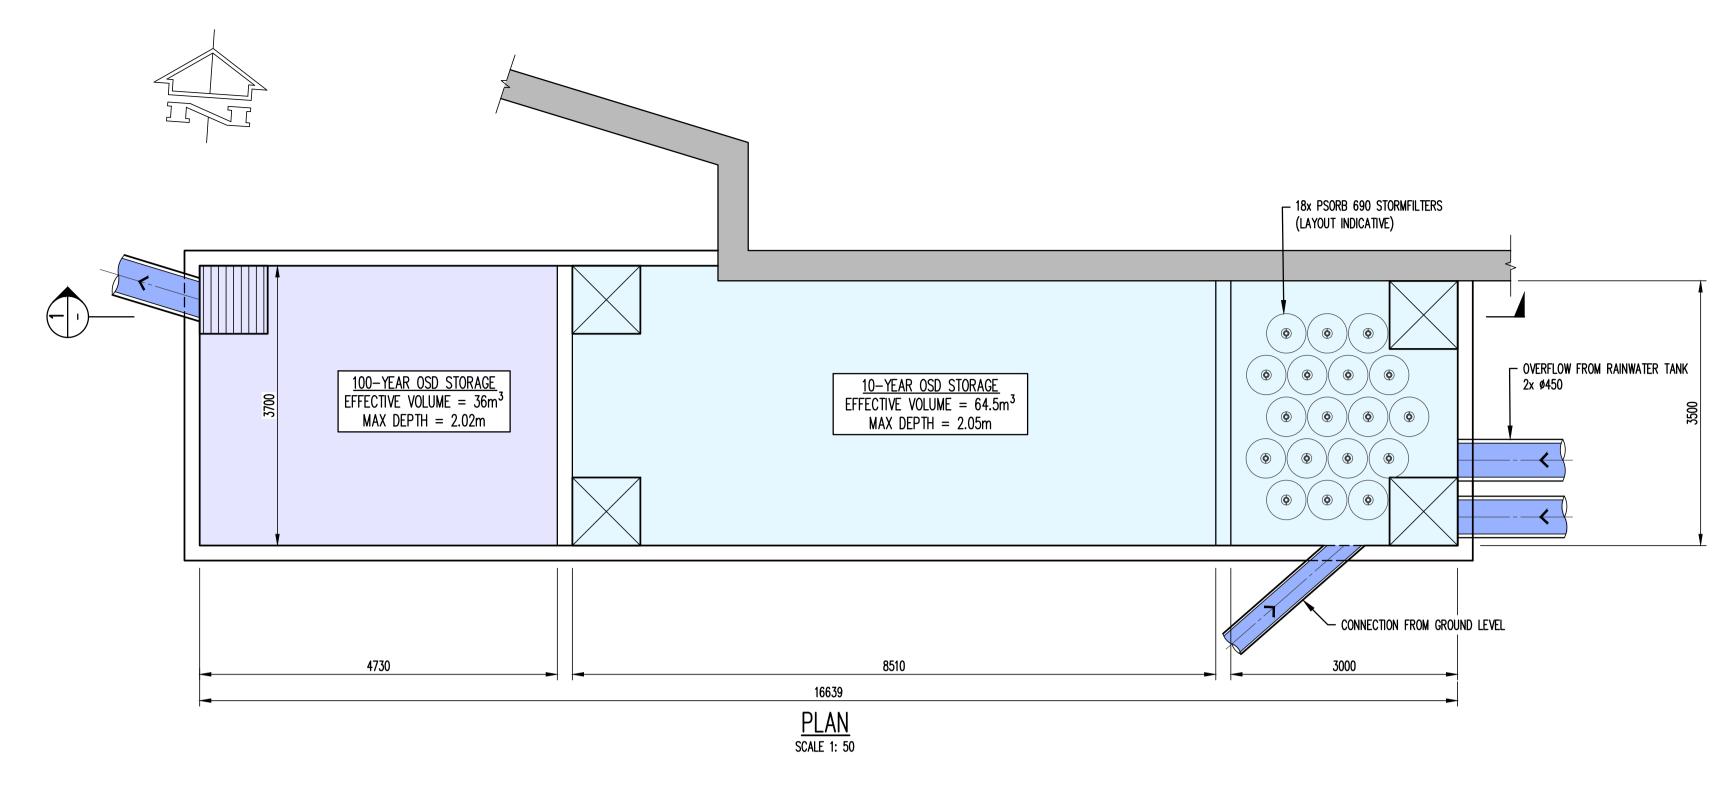


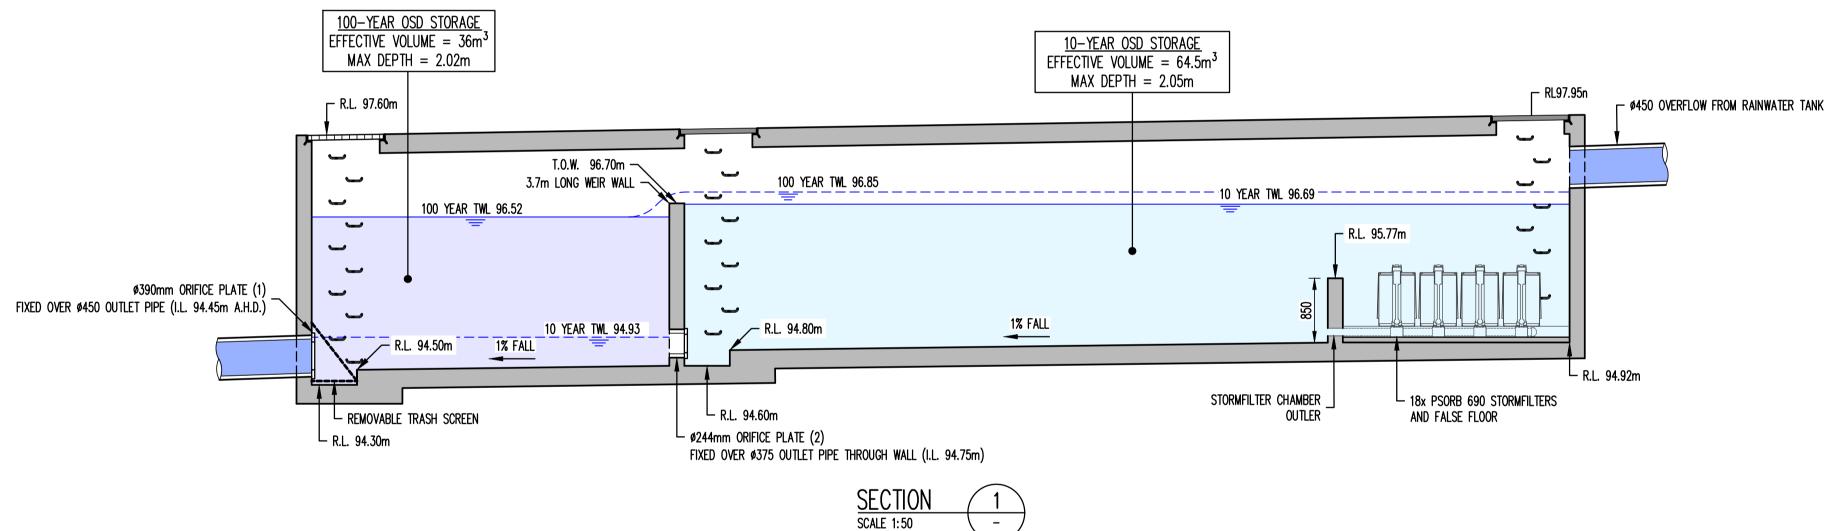

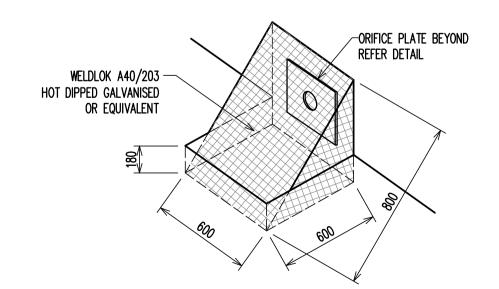

TRASH SCREEN DETAIL

3mm STAINLESS STEEL PLATE FIXED WITH 4 x 12mm MASONRY ANCHORS 3900 ORIFICE PLATE 1 DETAIL SCALE 1: 5

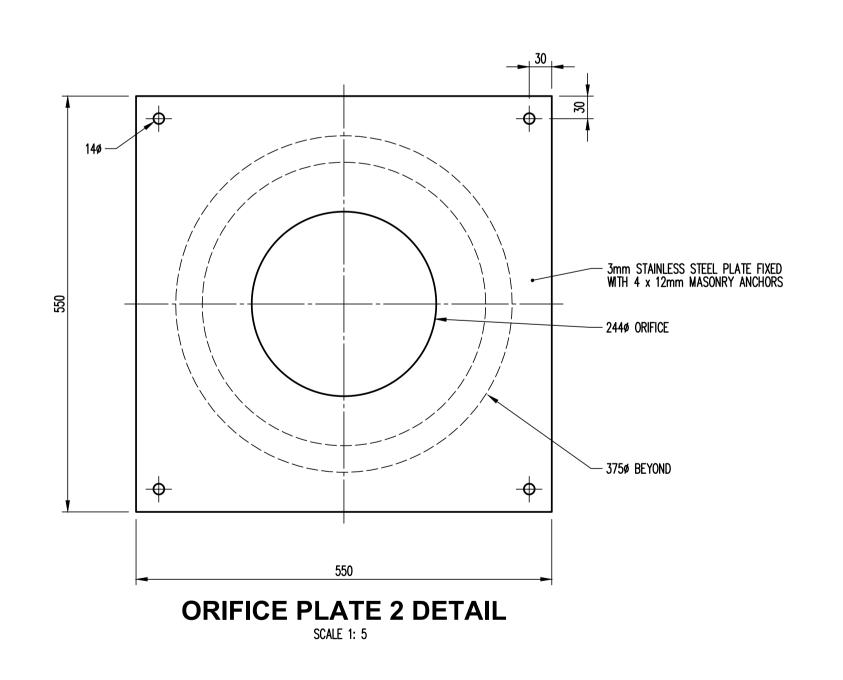

PRELIMINARY NOT TO BE USED FOR CONSTRUCTION

						Architect
						WARREN AND MAHONEY
						Suite 13.03, Plaza Building
						95 Pitt Street
P2 PRELIMINARY	DM NS 06.08.21					Sydney NSW 2000
P1 ISSUE FOR DA	DM NS 11.06.21					Australia +61 2 8021 9809
Rev Description	Eng Draft Date	Rev Description	Eng Draft Date	Rev Description	Eng Draft Date	australia@warrenandmahoney.com

T	Structural Civil Traffic Façade
612 9439 7288	I Level 6, No. 73 Miller Street North Sydney NSW 2060


Floject	ı
ORAN PARK LEISURE CENTRE	

Sheet Subject
OSD TANK DETAIL

191905		C53	P2
Job No		Drawing No	Revision
AS SHOWN	SH		
Scale : A1	Drawn	Auth	orised

Plot File Created: Aug 06, 2021 - 4:41pm

Sign locations Concept Design

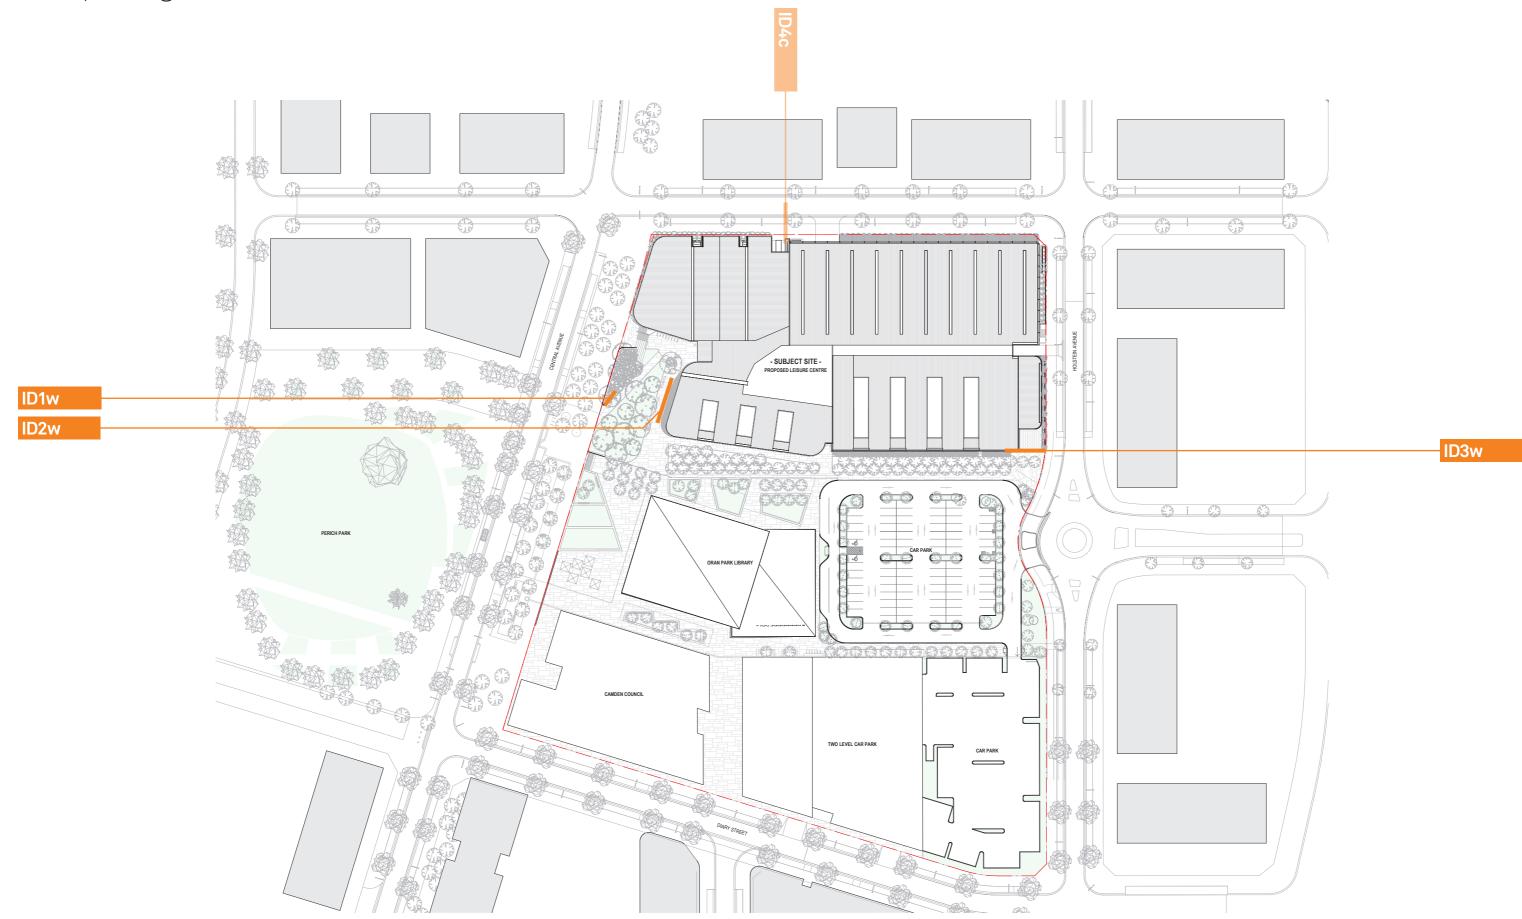









Drawing pages

Concept Design

NOTE



Site identification

Wall mounted Single sided Non-illuminated




Building Identification

Facade mounted Single sided Halo illuminated




ALL DIMENSIONS TO BE CONFIRMED ON-SITE BEFORE MANUFACTURE

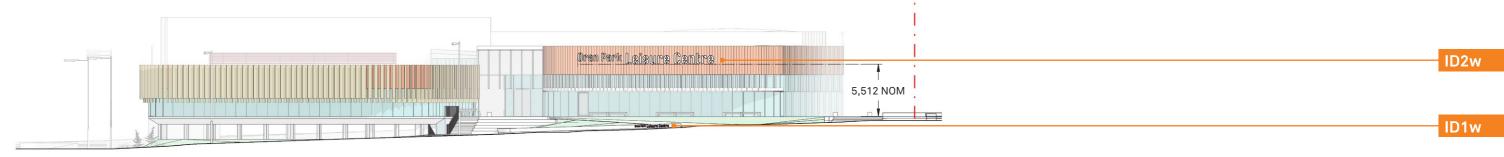

WEST ELEVATION
SCALE 1:400 @ A3



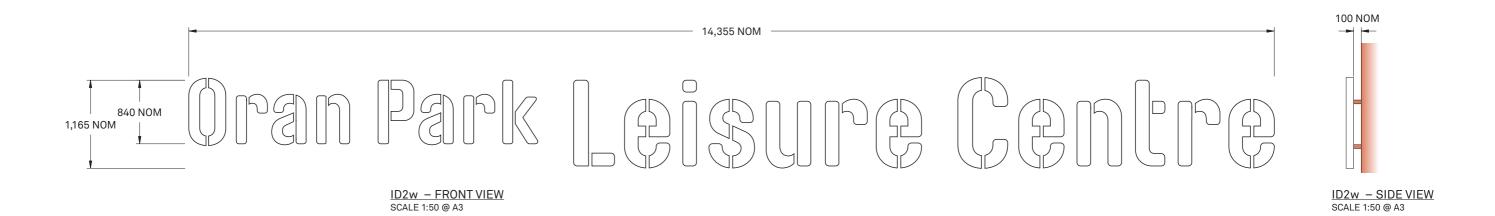

Drawing pages

Concept Design




Building Identification Facade mounted Single sided Halo illuminated

NOTE


ALL DIMENSIONS TO BE CONFIRMED ON-SITE BEFORE MANUFACTURE SIGNAGE IS SCALED RELATIVE TO DRAWING:

EXTERNAL ELEVATIONS-WORK IN PROGRESS -A20.001- 9/04/2021

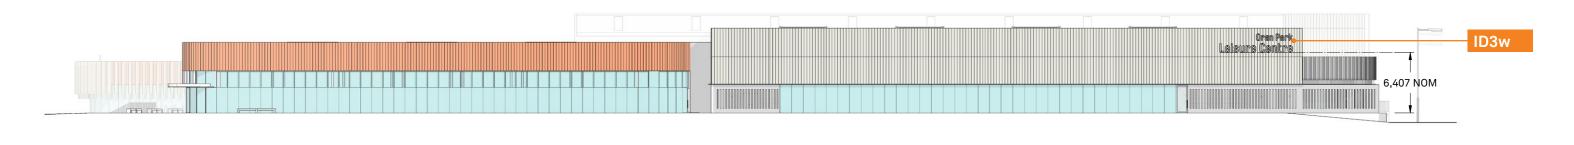

SOUTH ELEVATION

SCALE 1:400 @ A3

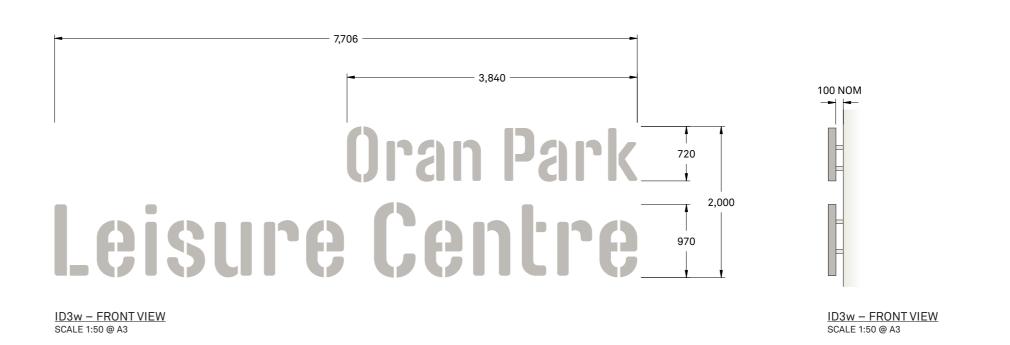

Drawing pages


Concept Design



Parking entry Identification Cantilevered Double sided Internally illuminated


NOTE

ALL DIMENSIONS TO BE CONFIRMED ON-SITE BEFORE MANUFACTURE SIGNAGE IS SCALED RELATIVE TO DRAWING: EXTERNAL ELEVATIONS-WORK IN PROGRESS -A20.001- 9/04/2021

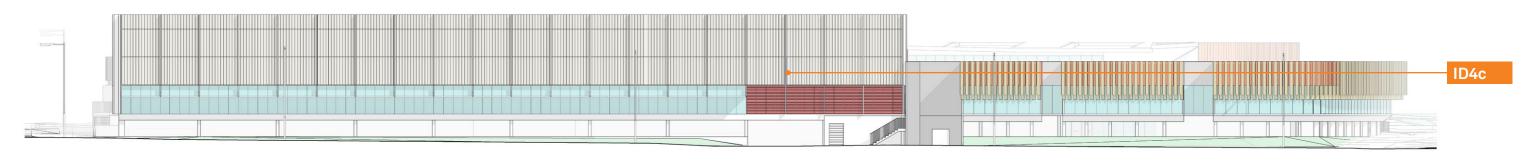


NORTH ELEVATION

SCALE 1:400 @ A3

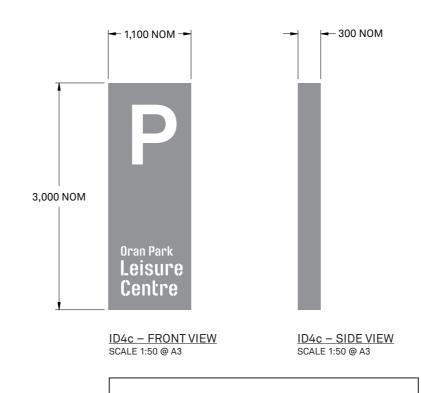

INDICATIVE DESIGN ONLY NOT DESIGNED IN THIS PACKAGE OF WORK

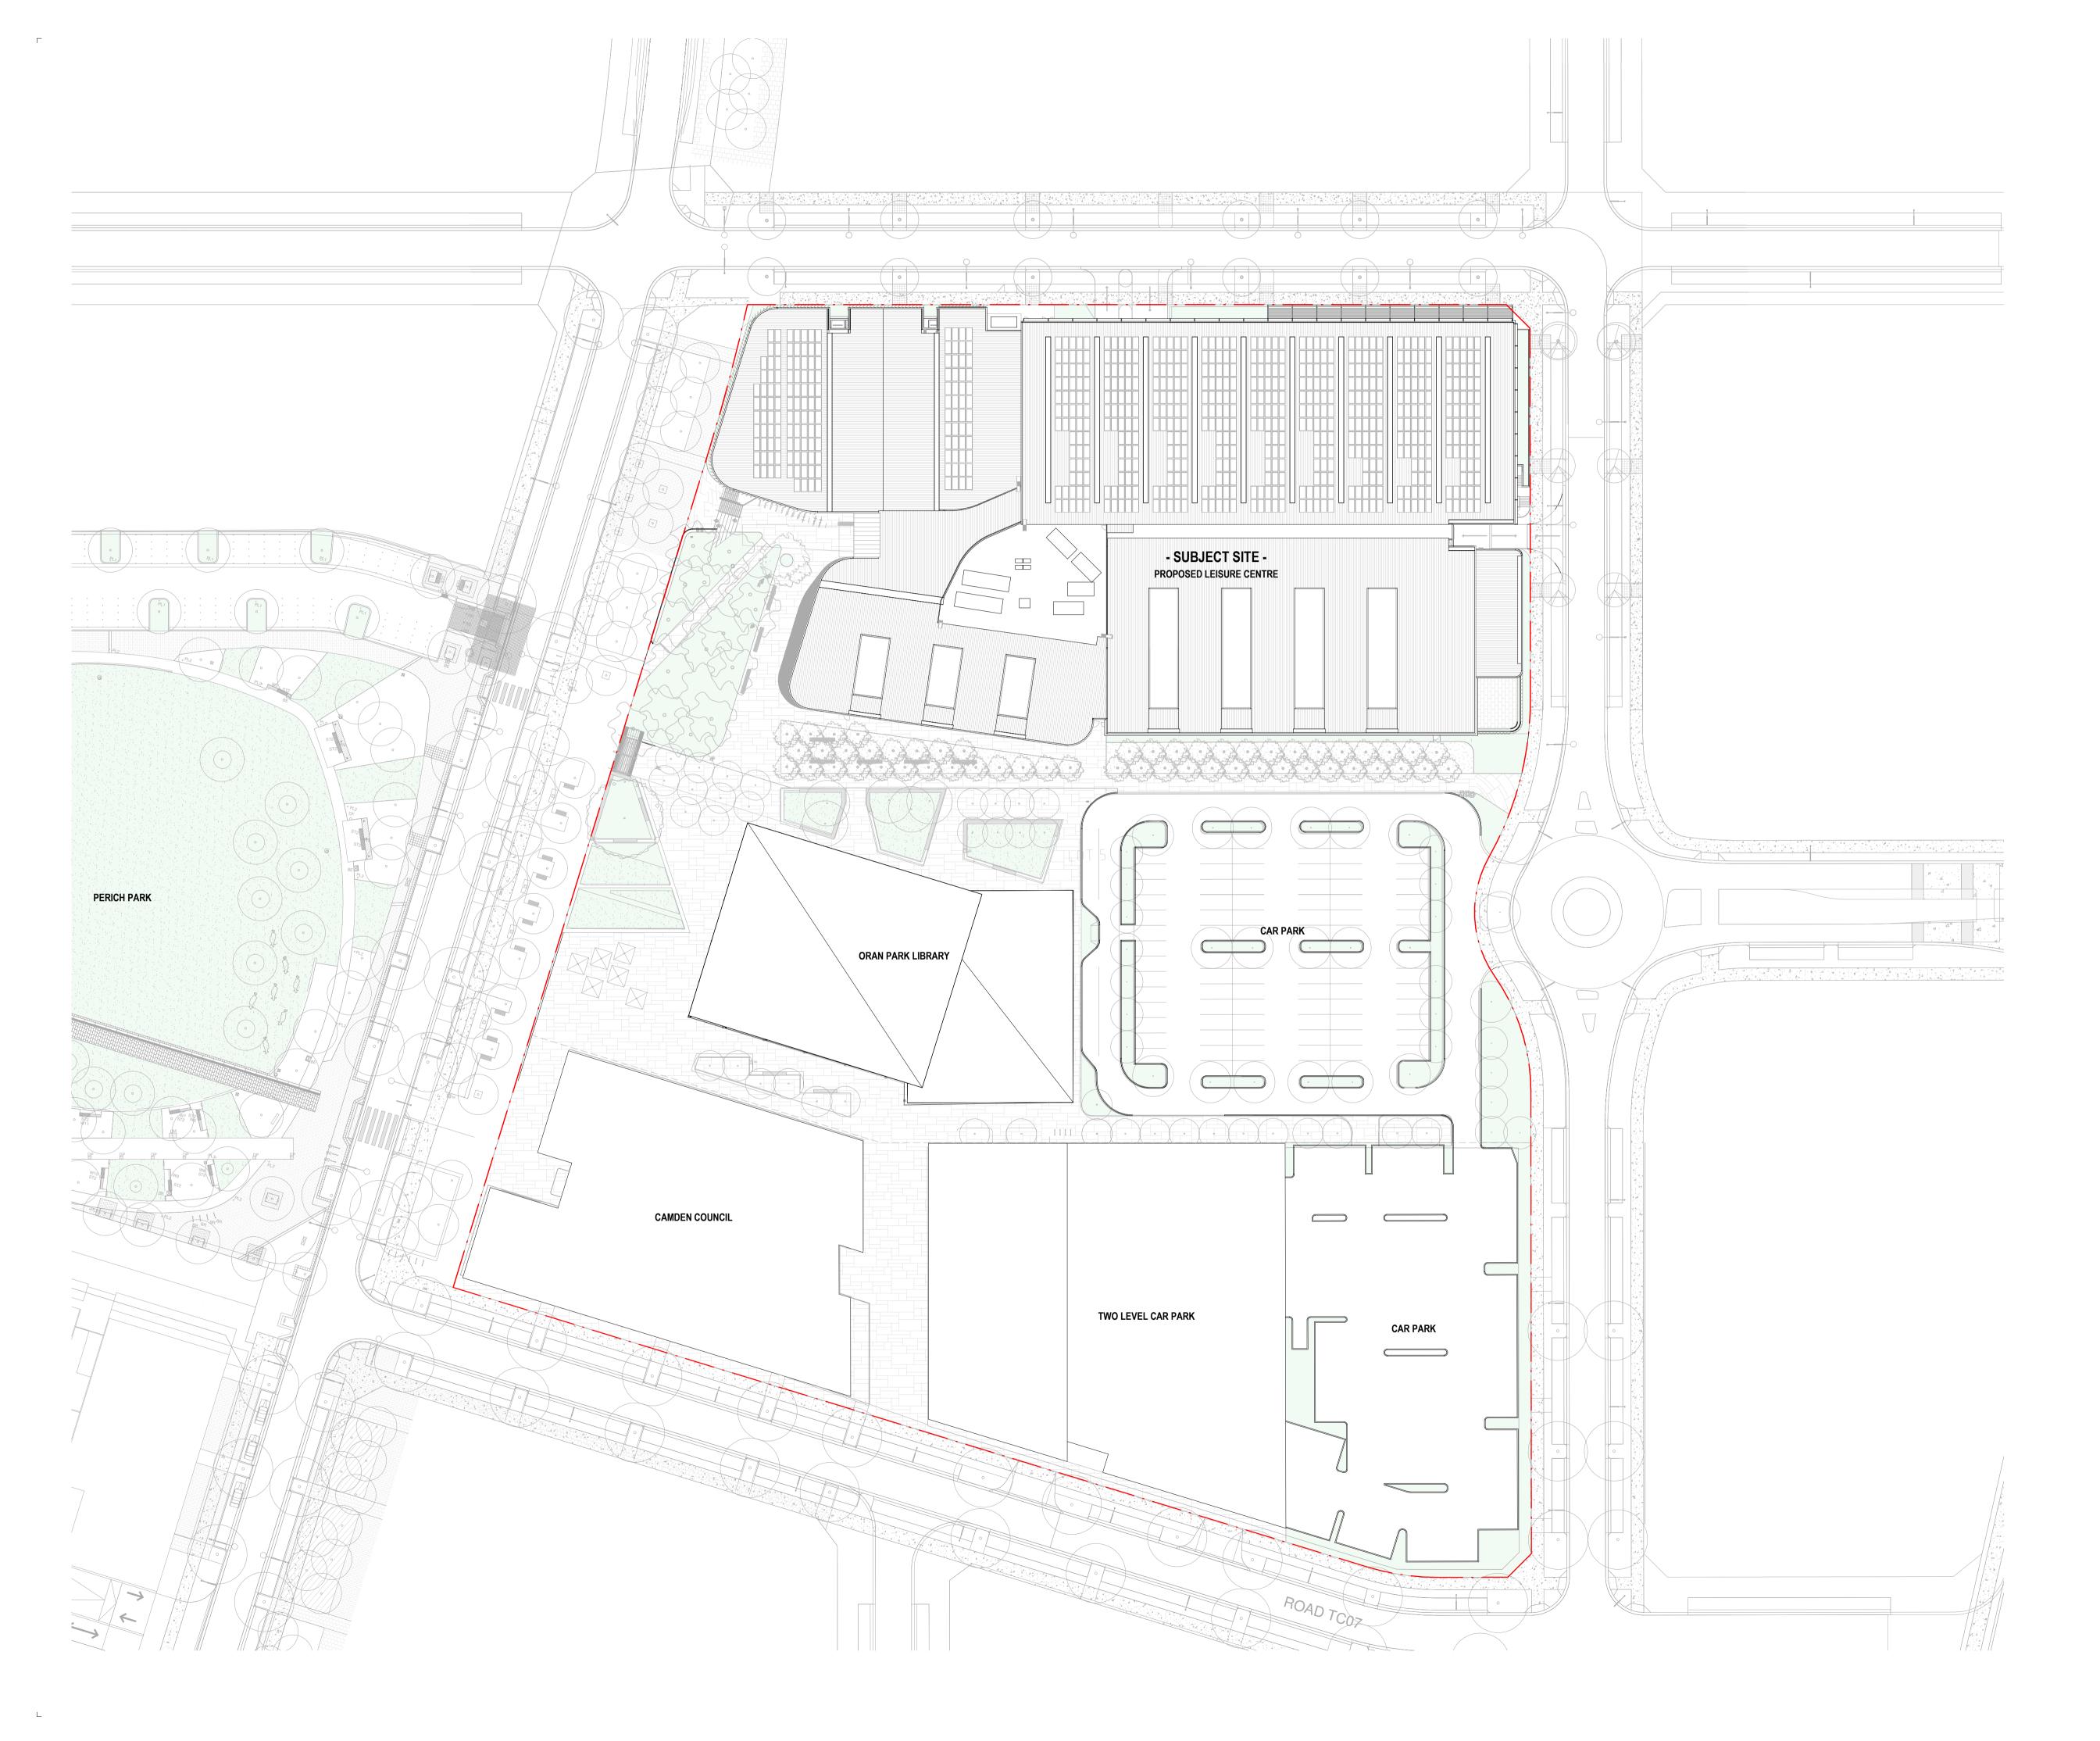


All dimension to be verified on site before producing shop drawings or commencing any work.

Do not scale. The copyright of this drawing remains with Warren and Mahoney Architects Australia Pty Ltd.

Revision

A 25.06.21 DEVELOPMENT APPLICATION

Note

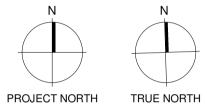

Client

Camden Council

Warren and Mahoney Architects Australia Pty Ltd

Suite 13.03, Plaza Building
Australia Square, 95 Pitt Street
Sydney, NSW 2000
Australia
Phone + 61 2 8021 9809
Nominated Architect:
Sven Ollmann ARB NSW 11123

Registered Architects and Designers www.warrenandmahoney.com

Project Title

Oran Park Leisure Centre Enter address here

Drawing Title

PROPOSED SITE

Drawing Status
DEVELOPMENT
APPLICATION
Drawing Details


1 : 500@ A
25.06.2
916
WAN
WAN


Drawing No

A03.001



WARREN AND MAHONEY®

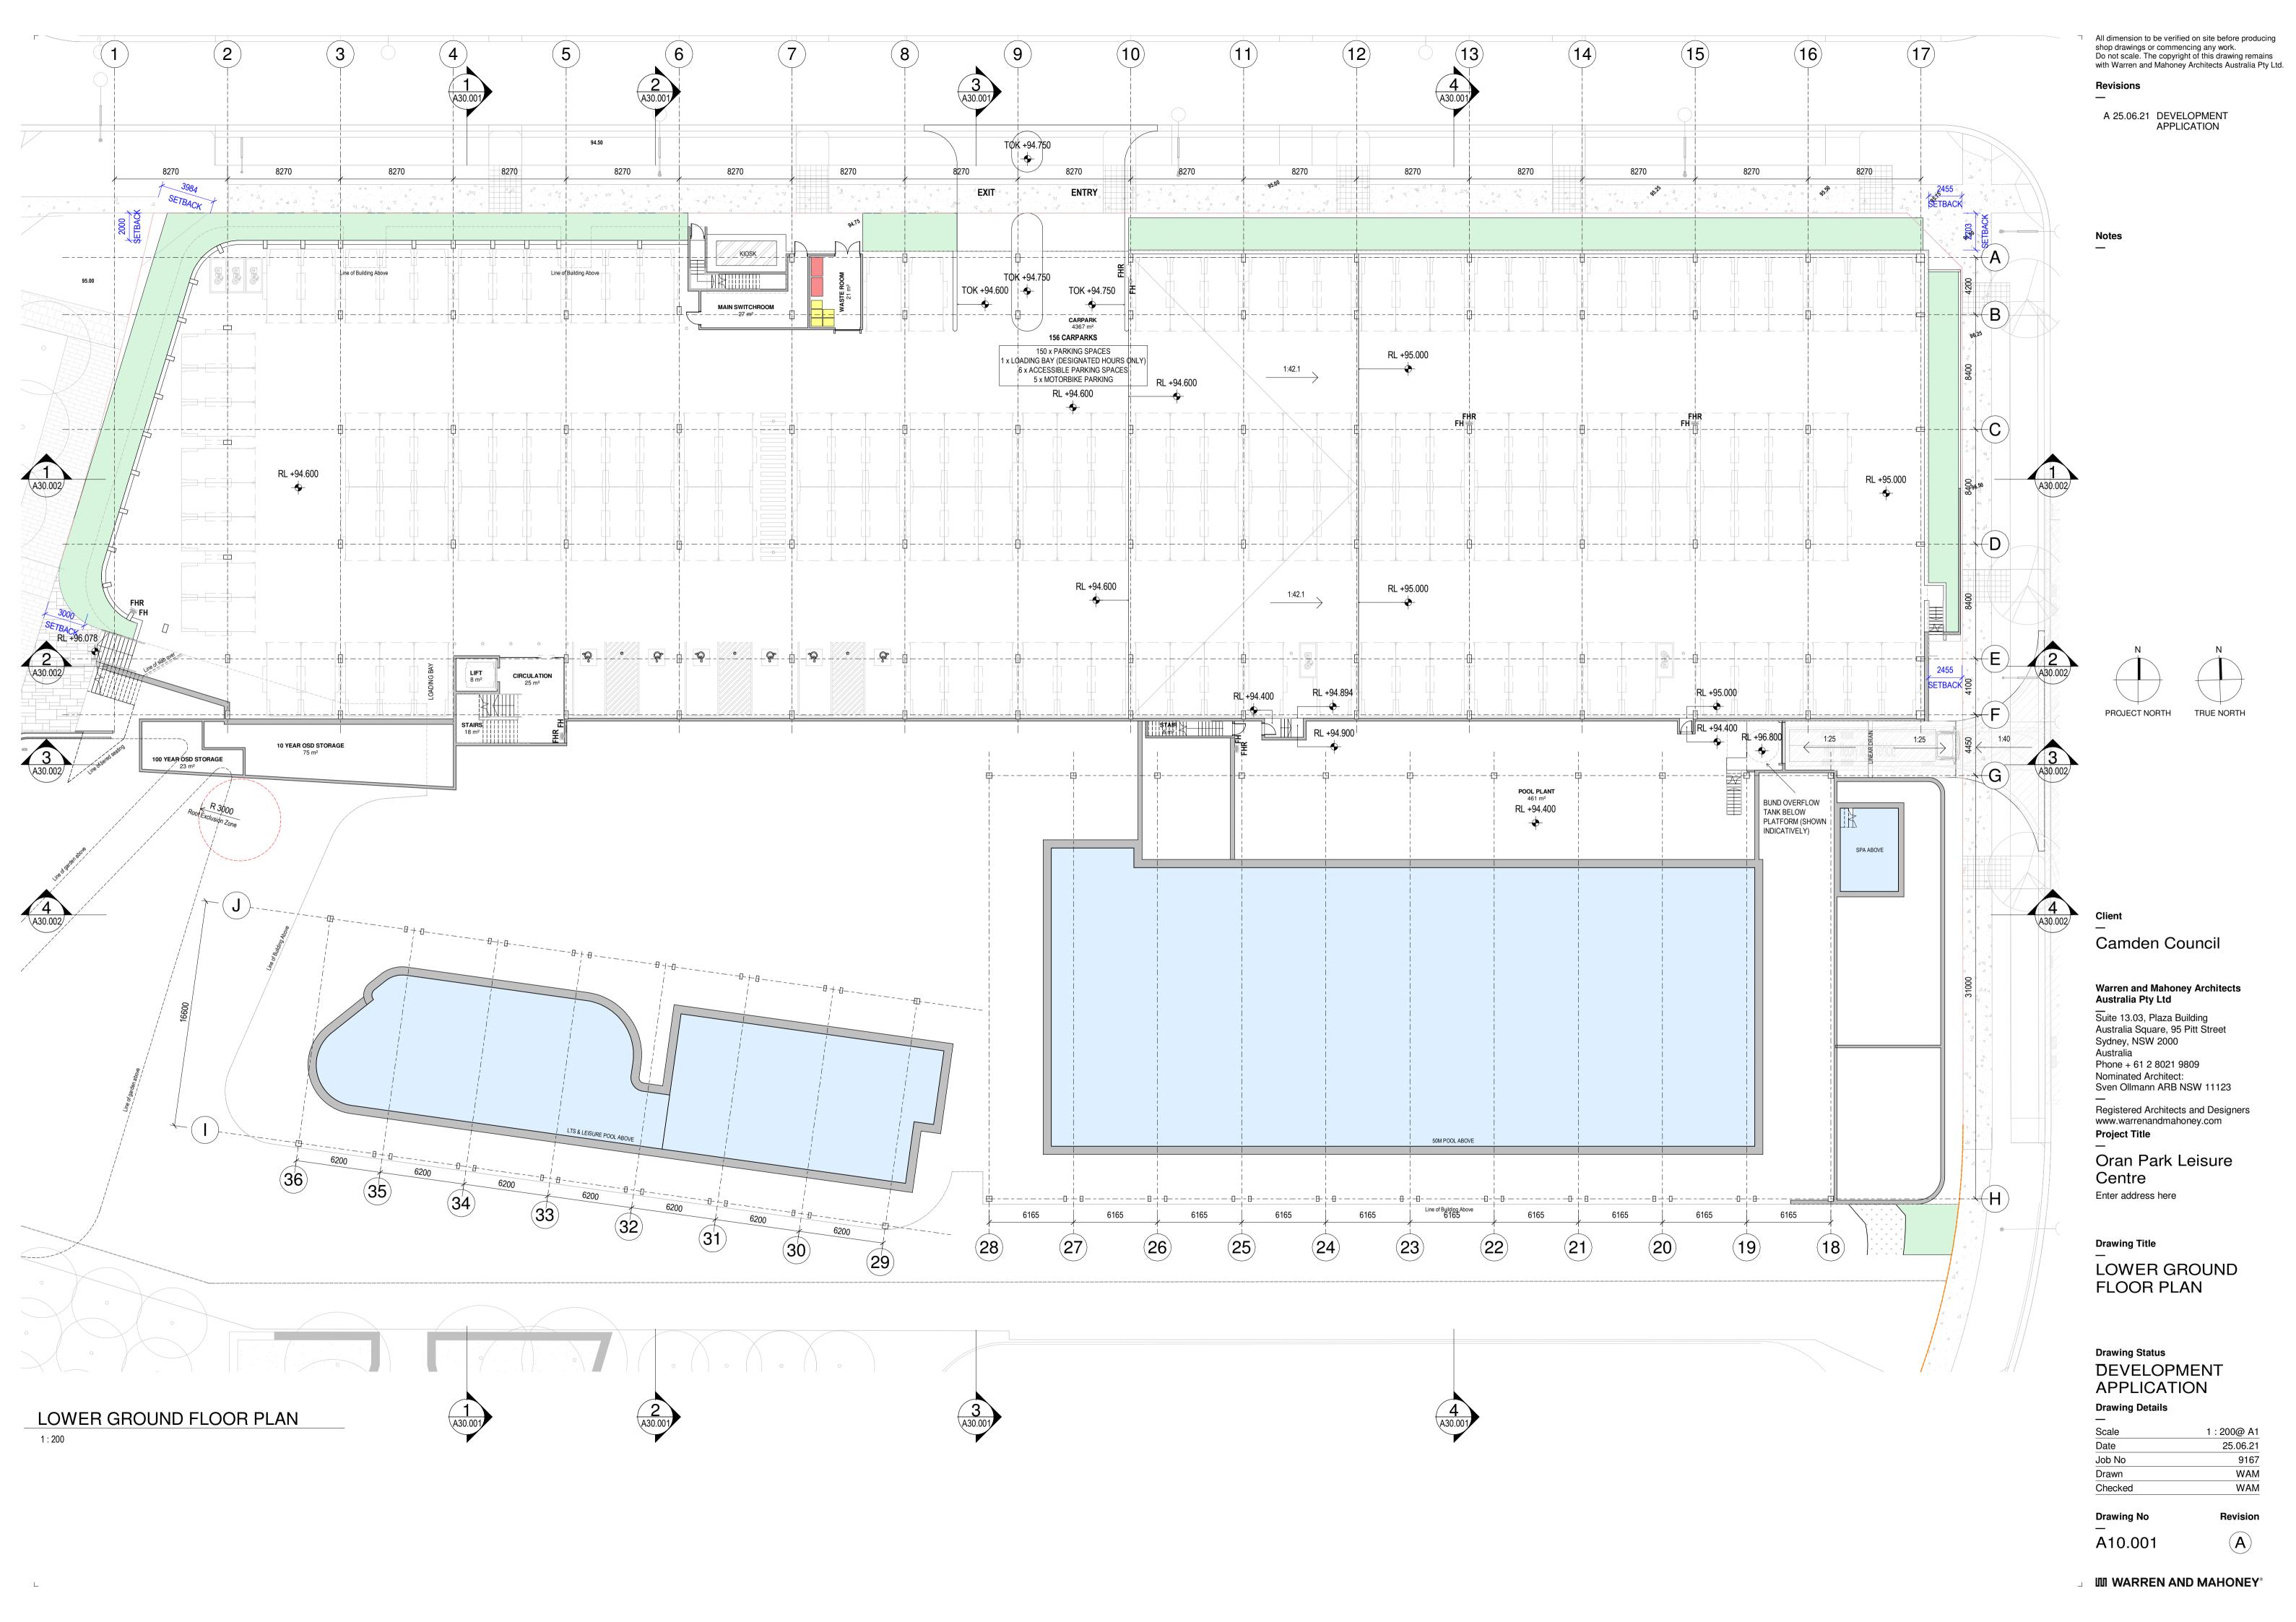

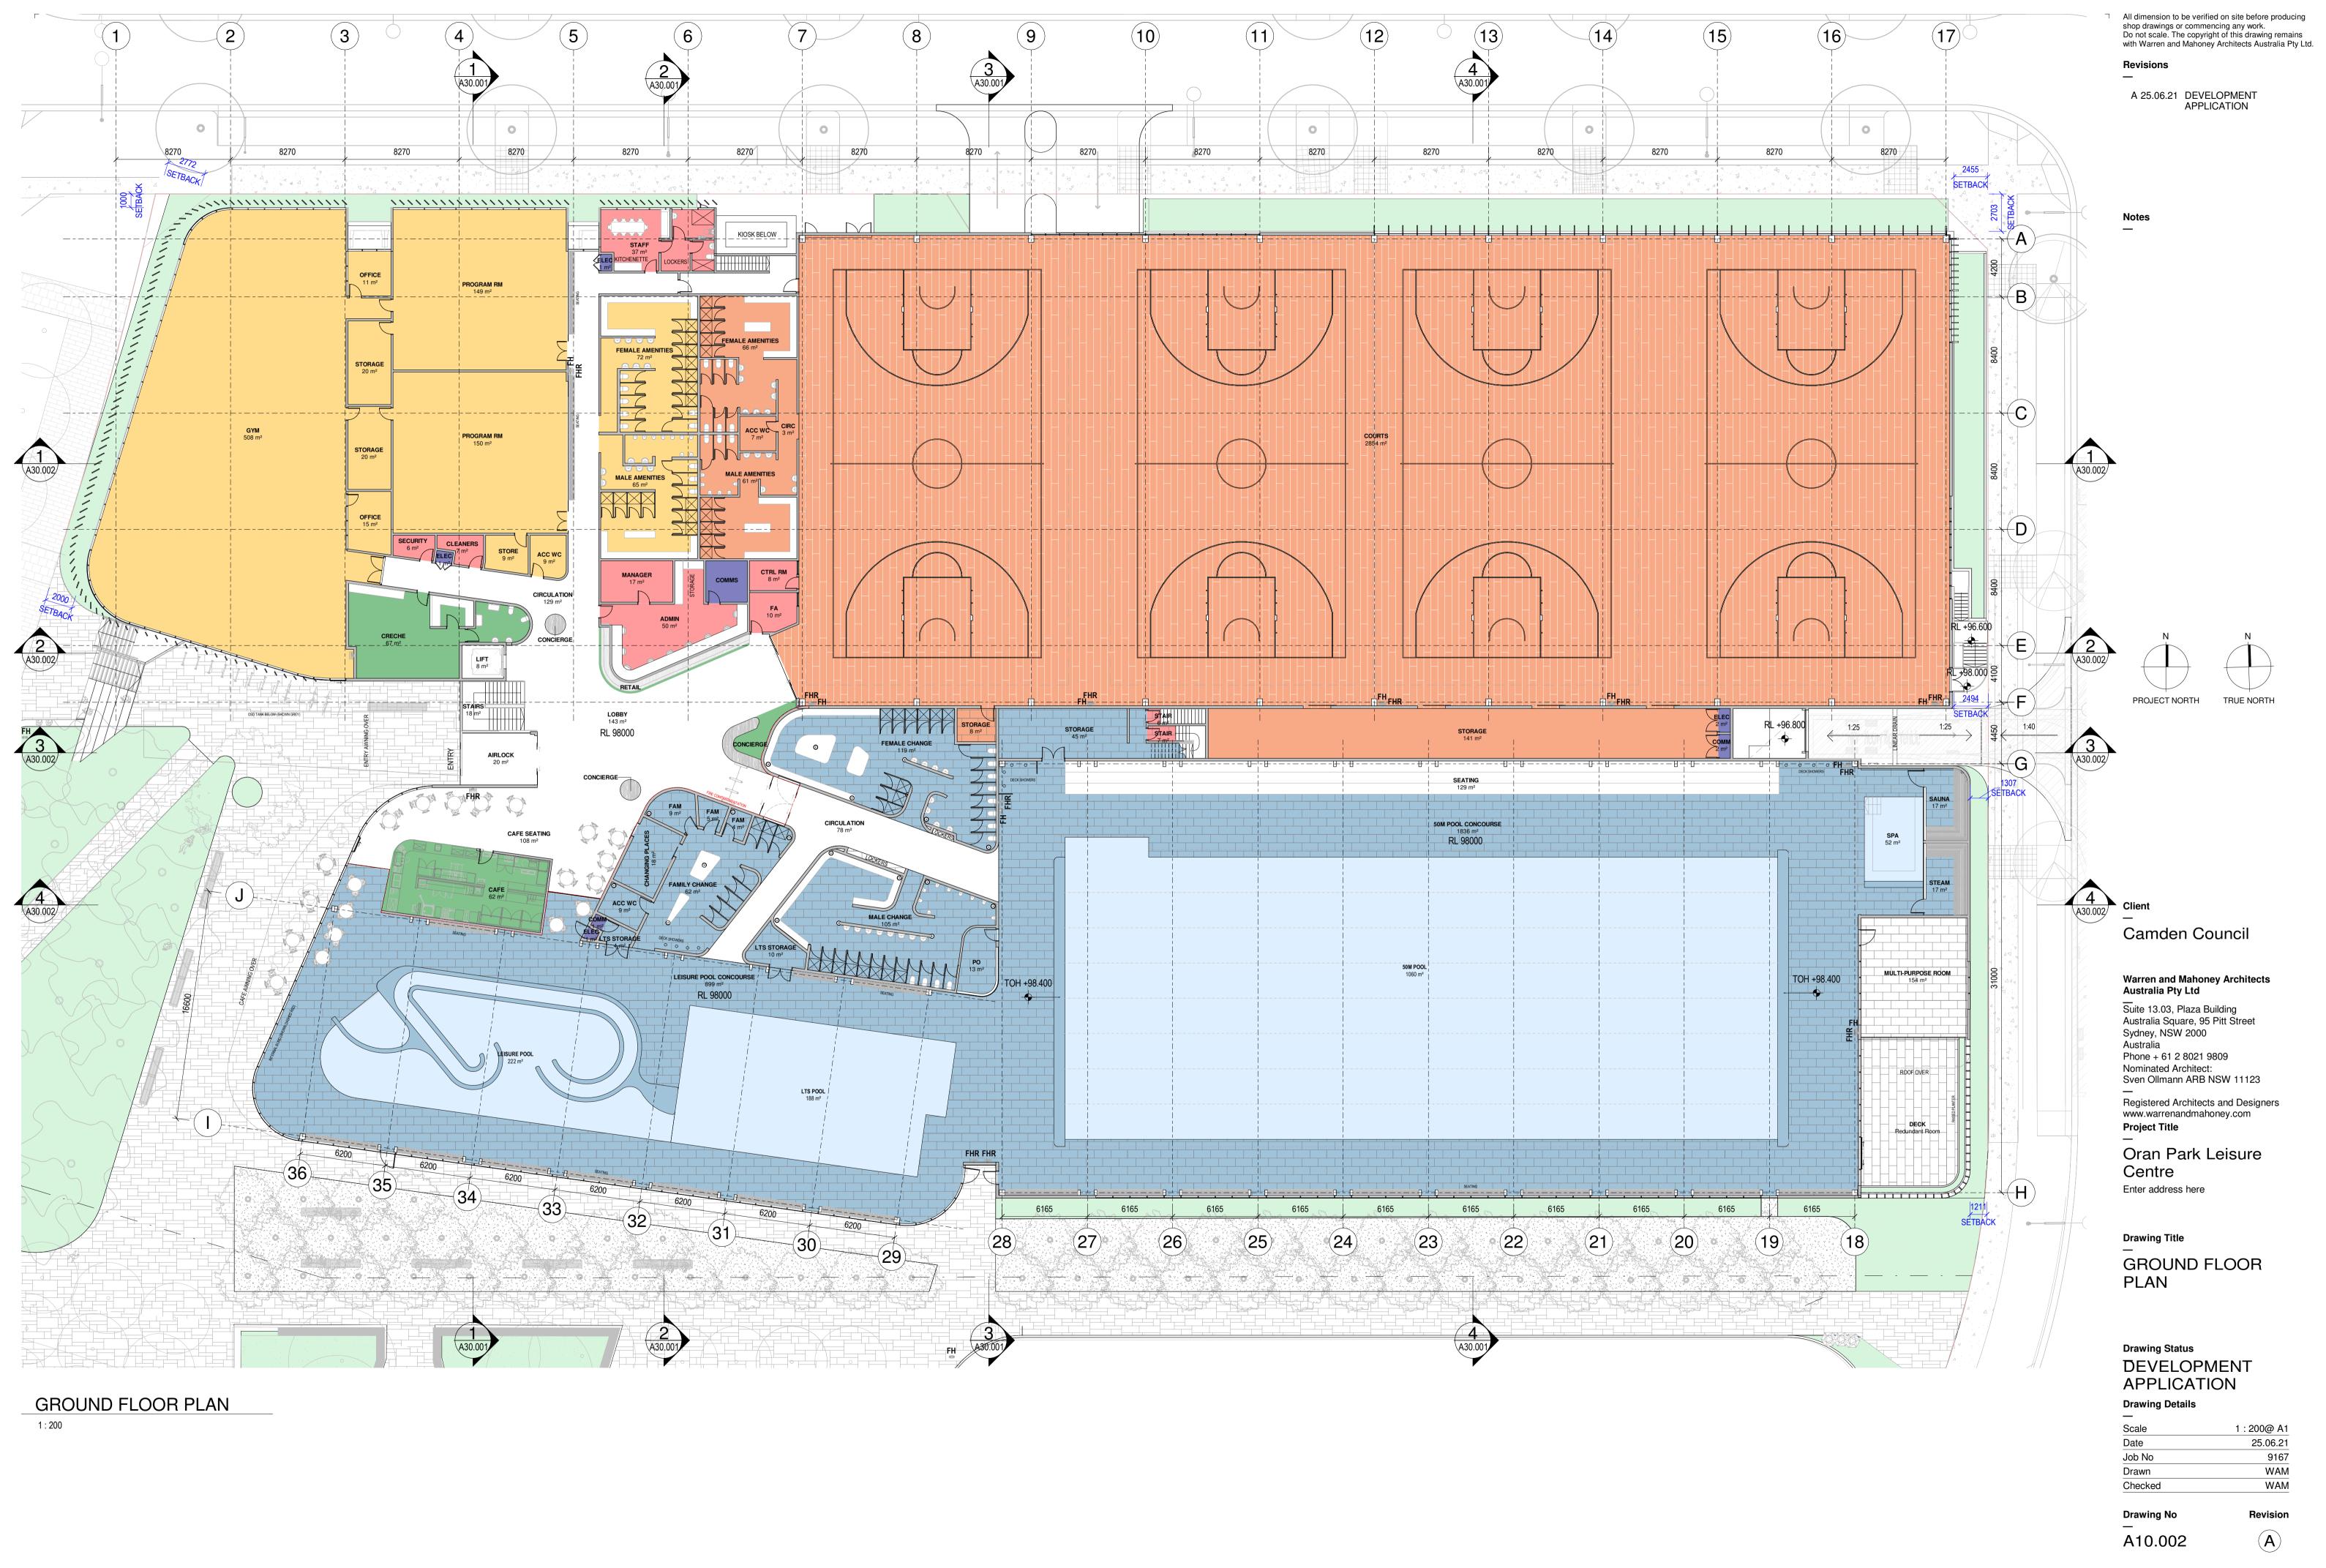



☐ All dimension to be verified on site before producing shop drawings or commencing any work.

Do not scale. The copyright of this drawing remains with Warren and Mahoney Architects Australia Pty Ltd. A 25.06.21 DEVELOPMENT APPLICATION ▼ 108.500 ROOF COURTS RL +108.500 ▼ 107.000 ROOF 50M POOL ▼ 105.500 ROOF LEISURE POOL CS-103 CS-101 GL-002 LS-002 RE-001 GL-001 GL-001 GL-001 GL-001 ♥ <u>98.000</u> _ L-GF KIOSK NORTH ELEVATION 1:200 D (G) B ▼ 108.500 ROOF COURTS RL +108.490 RL +106.990 ▼ 107.000 ROOF 50M POOL ▼ 105.500 ROOF LEISURE POOL CS-102 CS-103 ▼ 103.500 ROOF GYM ▼ 103.300 ROOF PLANT CS-010 RE-001 SC-001 GL-001 RE-001 RE-001 LS-002 RE-001 RE-001 ♥ 94.600 L-B1 **EAST ELEVATION** 1:200 ▼ 108.500 ROOF COURTS RS-001 Client — RL +107.000 Camden Council ▼ 107.000 _ _ _ _ _ ROOF 50M POOL RL +105.500 CS-103 ▼ 105.500 ROOF LEISURE POOL CS-101 ▼ 103.500 ROOF GYM Warren and Mahoney Architects Australia Pty Ltd CS-010 ROOF PLANT Suite 13.03, Plaza Building Australia Square, 95 Pitt Street GL-001 Sydney, NSW 2000 GL-001 RE-001 SC-001 Australia Phone + 61 2 8021 9809 Nominated Architect: Sven Ollmann ARB NSW 11123 ▼94.600 ₋ L-B1 Registered Architects and Designers www.warrenandmahoney.com **Project Title** Oran Park Leisure SOUTH ELEVATION Centre 1:200 Enter address here **Drawing Title** (H)B \bigcirc G **EXTERNAL ELEVATIONS** ▼ 108.500 ____ ROOF COURTS **ELEVATION LEGEND** ▼ 107.000 ROOF 50M POOL RL +105.500 ▼ CODE FINISH

CS-101

CS-002

GL-001

GL-002

Drawing Status PRE-FINISHED FIBRE CEMENT - TERRACOTTA Scale PRE-FINISHED FIBRE CEMENT - OFF WHITE PRE-FINISHED FIBRE CEMENT - GREY Job No Drawn Checked

CF-001

CS-001

CS-002

CS-004

CS-010

CS-101

CS-102

CS-103

GL-001

GL-002

LS-002

LS-003

RE-001

RS-001

SC-001

OFF FORM CONCRETE

ALUMINIUM BATTENS

TRANSLUCENT GLASS

ACRYLIC RENDER

ROOF SYSTEM

METAL SCREEN

FIXED METAL ACOUSTIC LOUVRE

FIXED METAL DOUBLE LOUVRE

50 METAL FIN

150 METAL FIN

GLASS

METAL CLADDING SYSTEM

DEVELOPMENT **APPLICATION Drawing Details**

> 1 : 200@ A1 25.06.21 9167 WAM WAM

Drawing No

 \bigcirc A20.001


Revision

▼ 105.500 ROOF LEISURE POOL

▼ 103.500 ____ ROOF GYM ▼ 103.300 ROOF PLANT

CS-101

RL +103.500

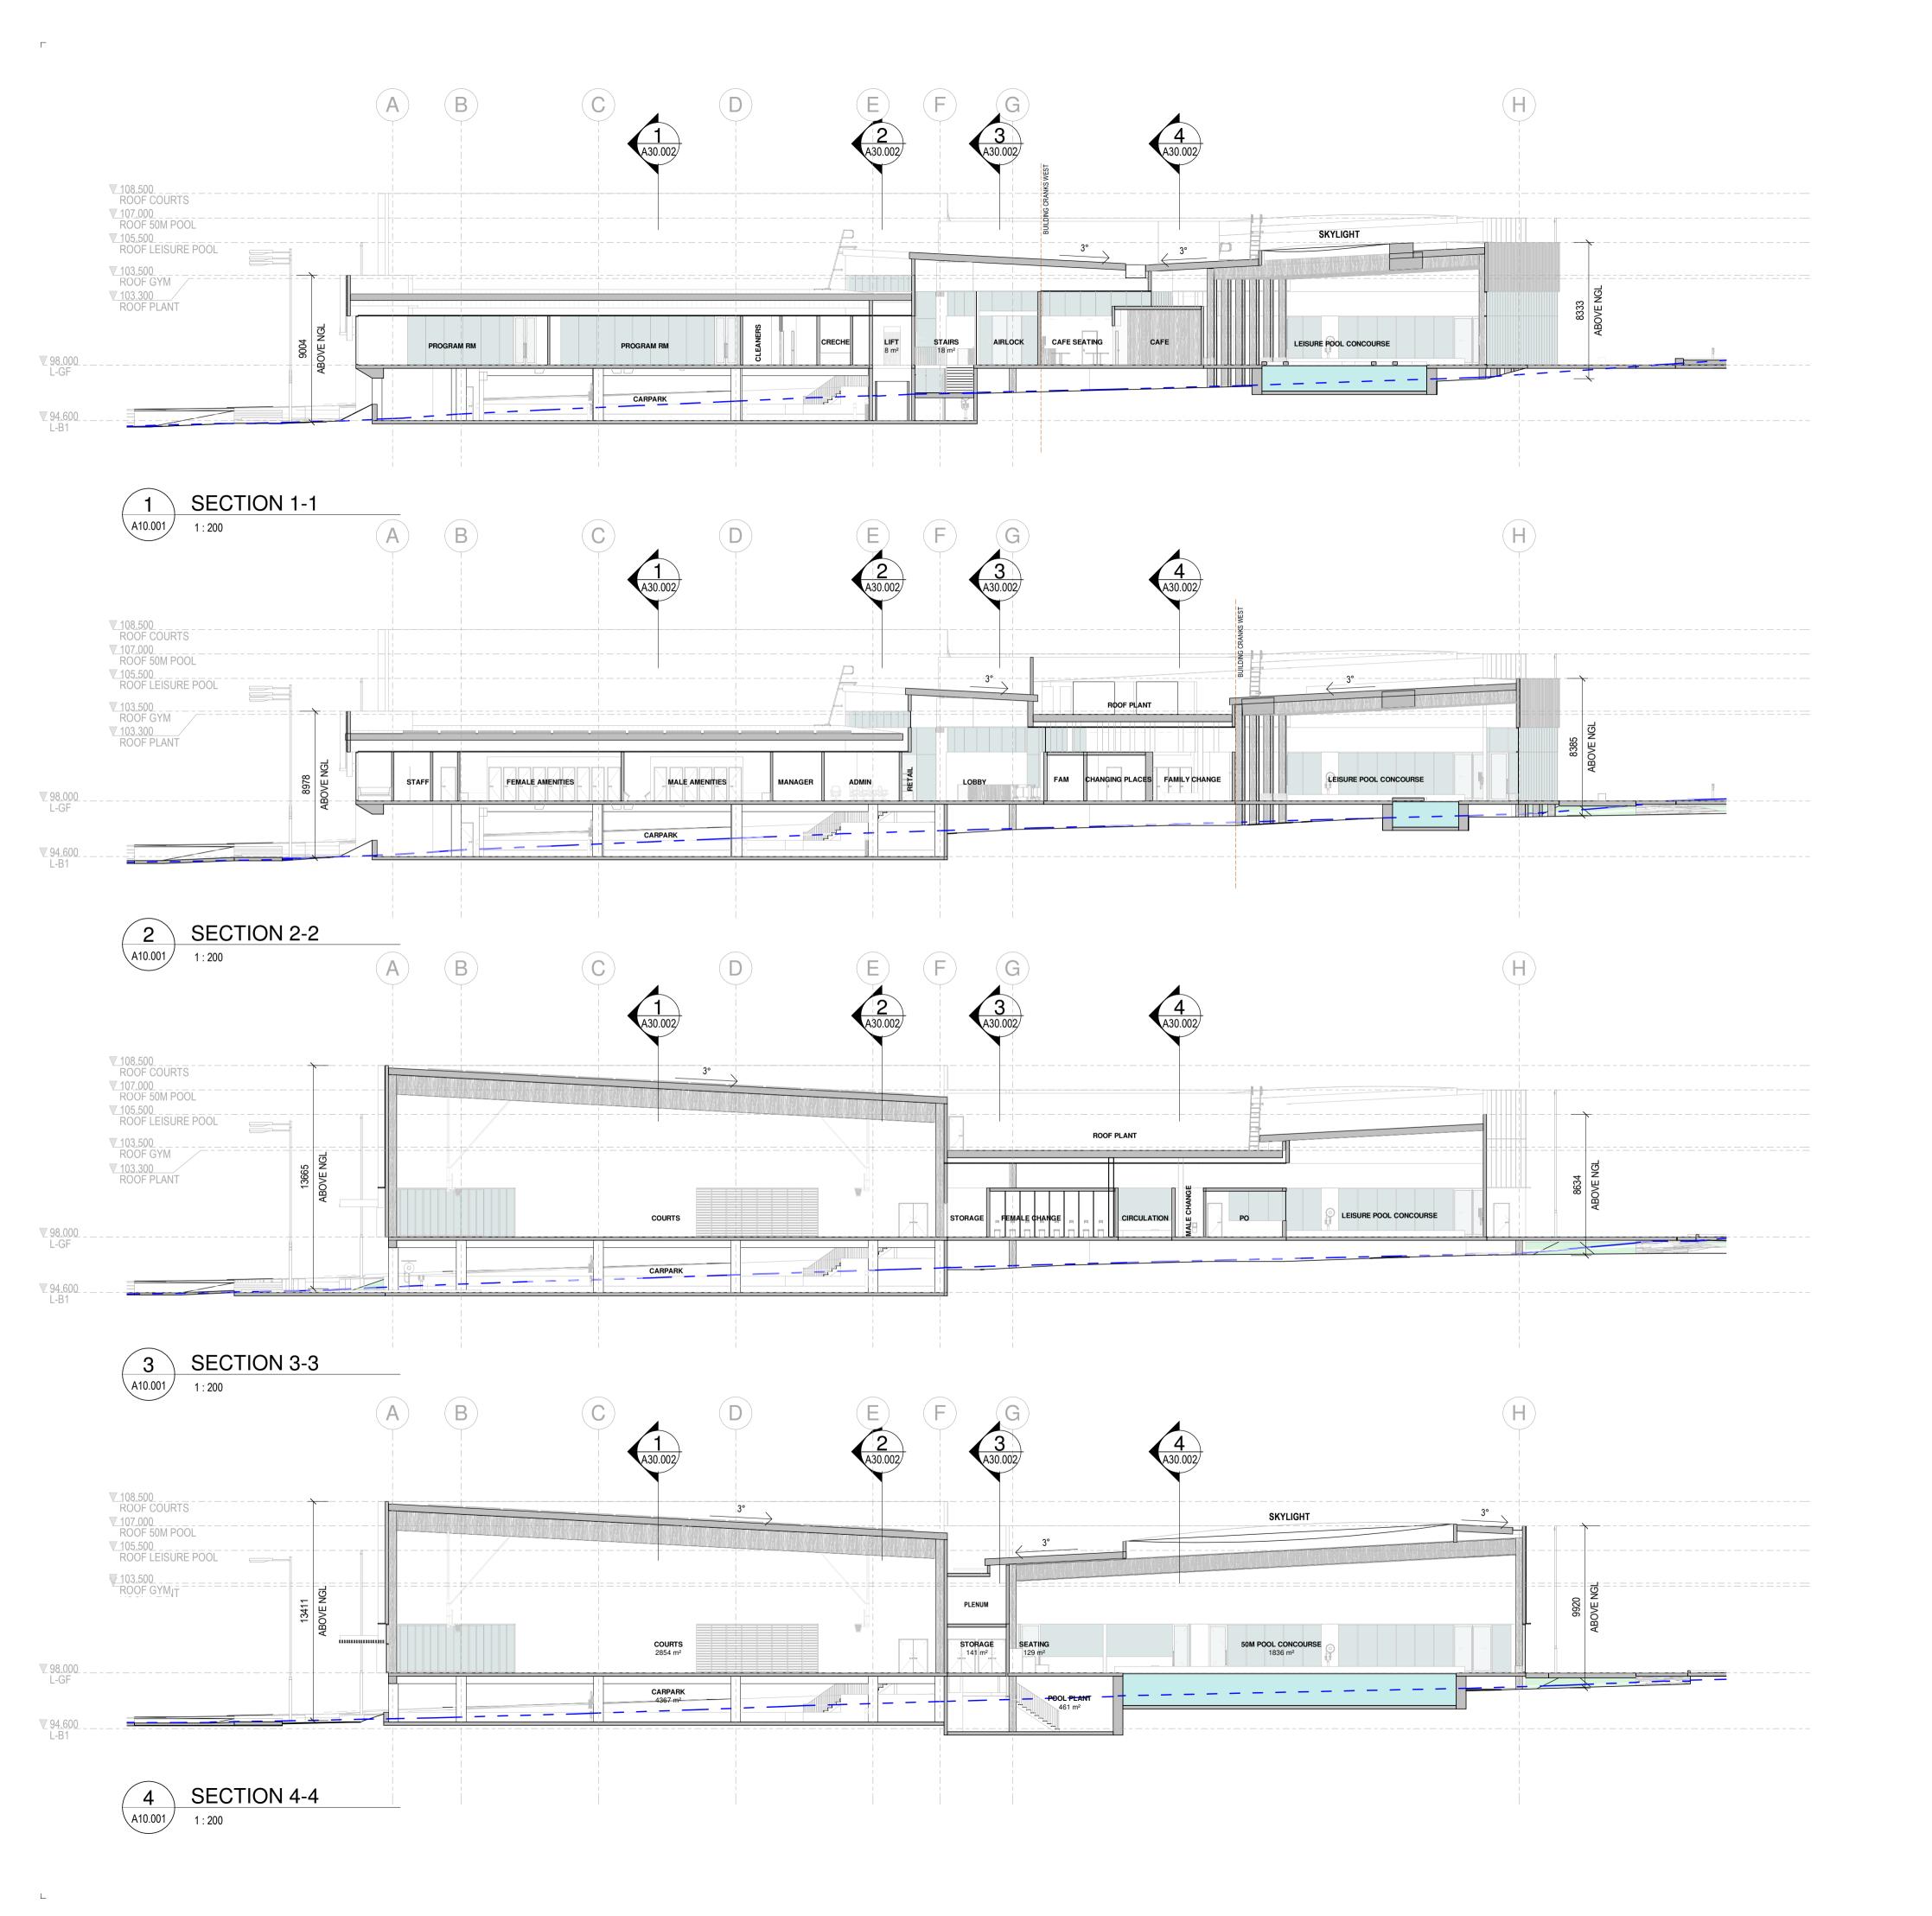

All dimension to be verified on site before producing shop drawings or commencing any work.

Do not scale. The copyright of this drawing remains with Warren and Mahoney Architects Australia Pty Ltd.

Revisions

A 25.06.21 DEVELOPMENT APPLICATION

Notes —

Client —

Camden Council

Warren and Mahoney Architects Australia Pty Ltd

Suite 13.03, Plaza Building
Australia Square, 95 Pitt Street
Sydney, NSW 2000
Australia
Phone + 61 2 8021 9809
Nominated Architect:
Sven Ollmann ARB NSW 11123

Registered Architects and Designers www.warrenandmahoney.com

Project Title

Oran Park Leisure Centre Enter address here

Drawing Title

SHORT BUILDING SECTIONS

Drawing Status
DEVELOPMENT
APPLICATION
Drawing Details


-	
Scale	1 : 200@ A1
Date	25.06.21
Job No	9167
Drawn	WAM
Checked	WAM

Drawing No

_ A30.001




 \bigcirc

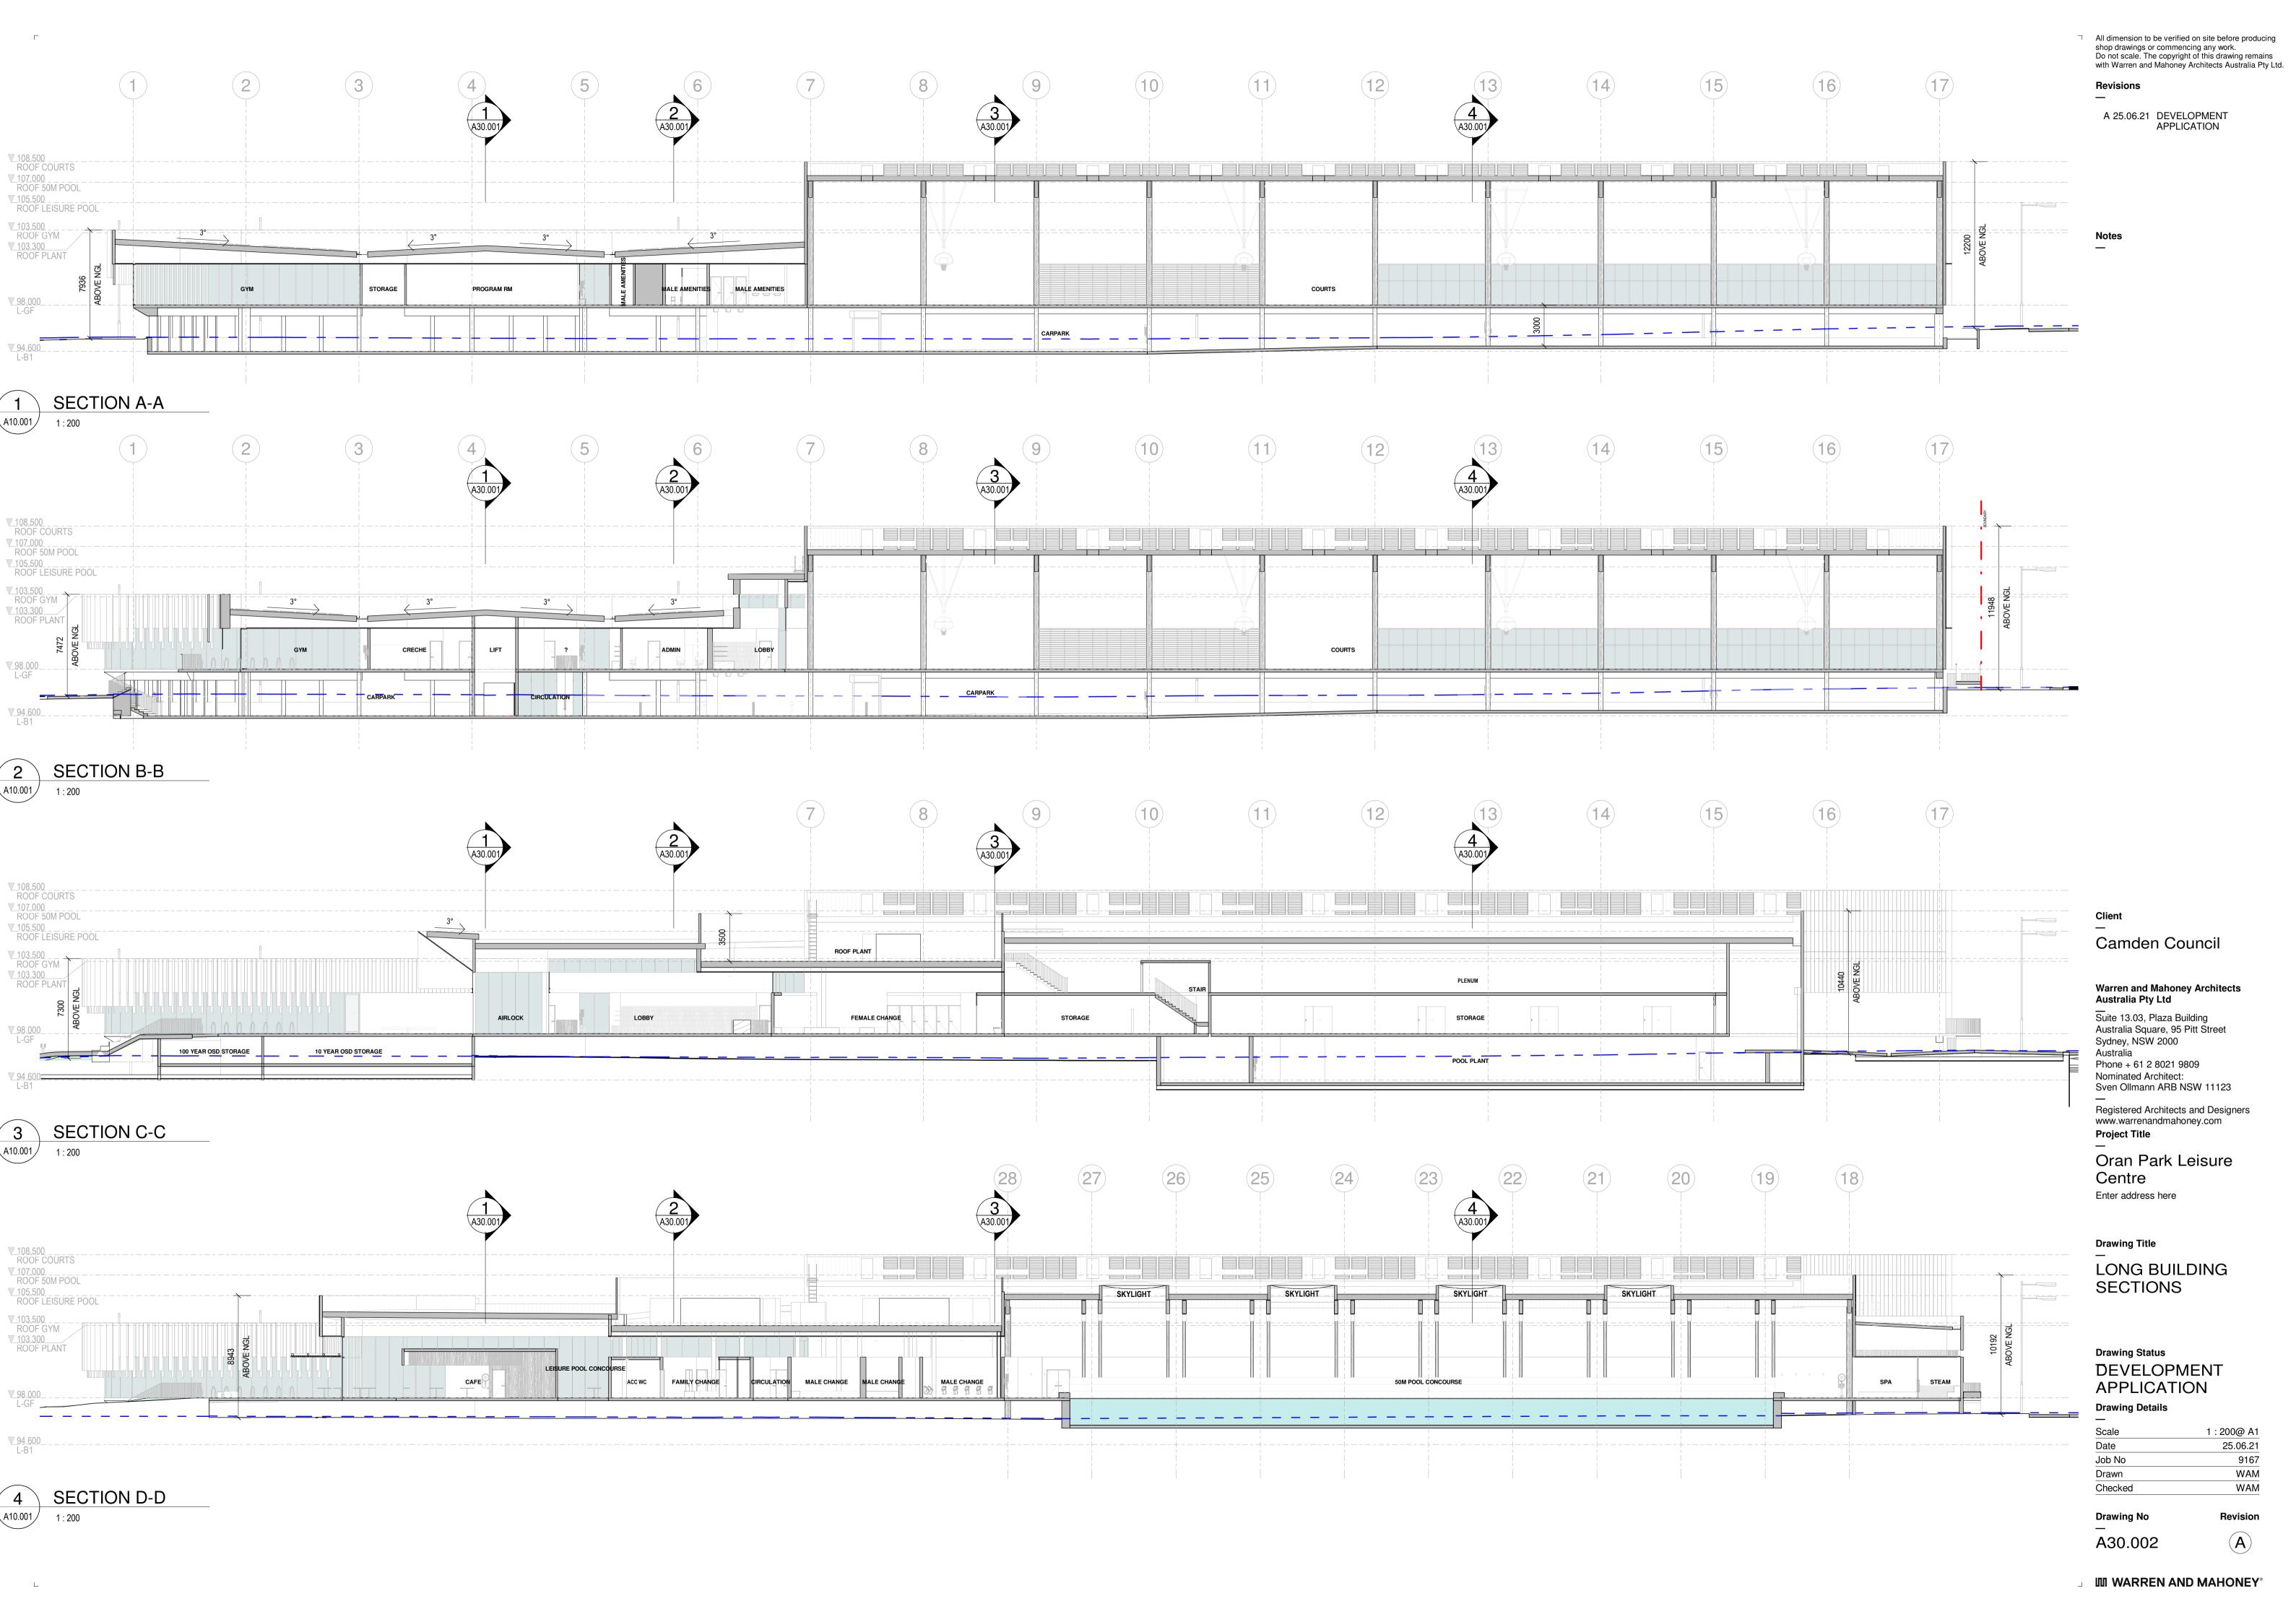


Lot Layout and Deep Soil Zone - Ground Floor

Future Development Hunter St Future Development Central Ave Perich Park Library Carpark Oran Park Library

Lot Layout and Deep Soil Zone - Lower Ground

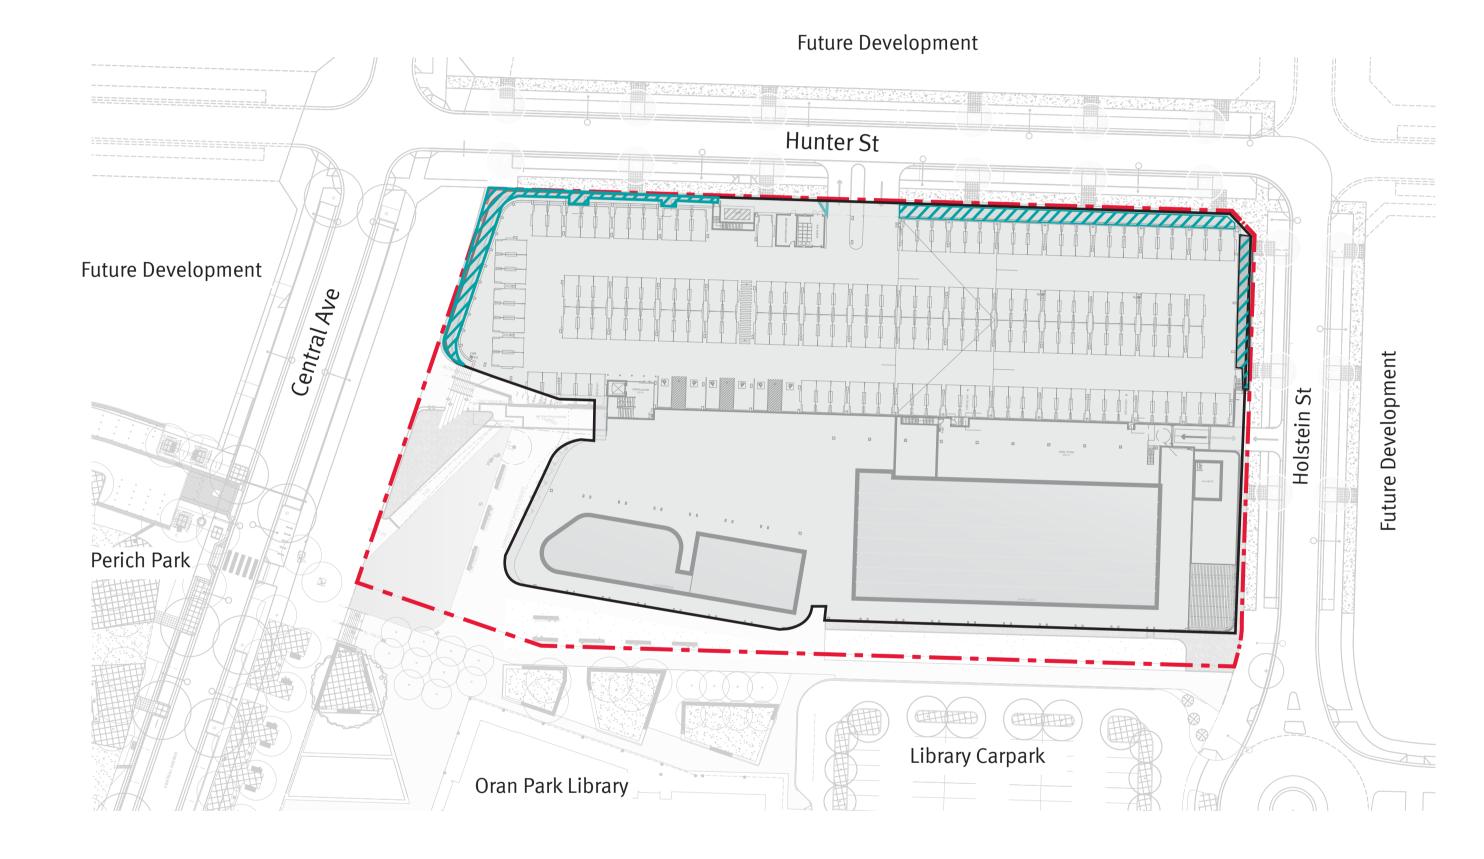



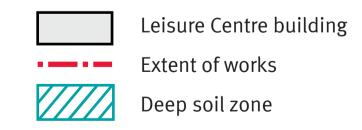









Date 23.04.21

Revisions

Issue

ADV

Description For Comment **Development Application** Drawn Check JM JM






Project Oran Park Leisure Centre Drawing title Design Analysis & Key Principles 01


Date May 2021 Scale Scale NTS

Drawing No. | Issue No. L02

Tree Strategy

Landscape Treatments

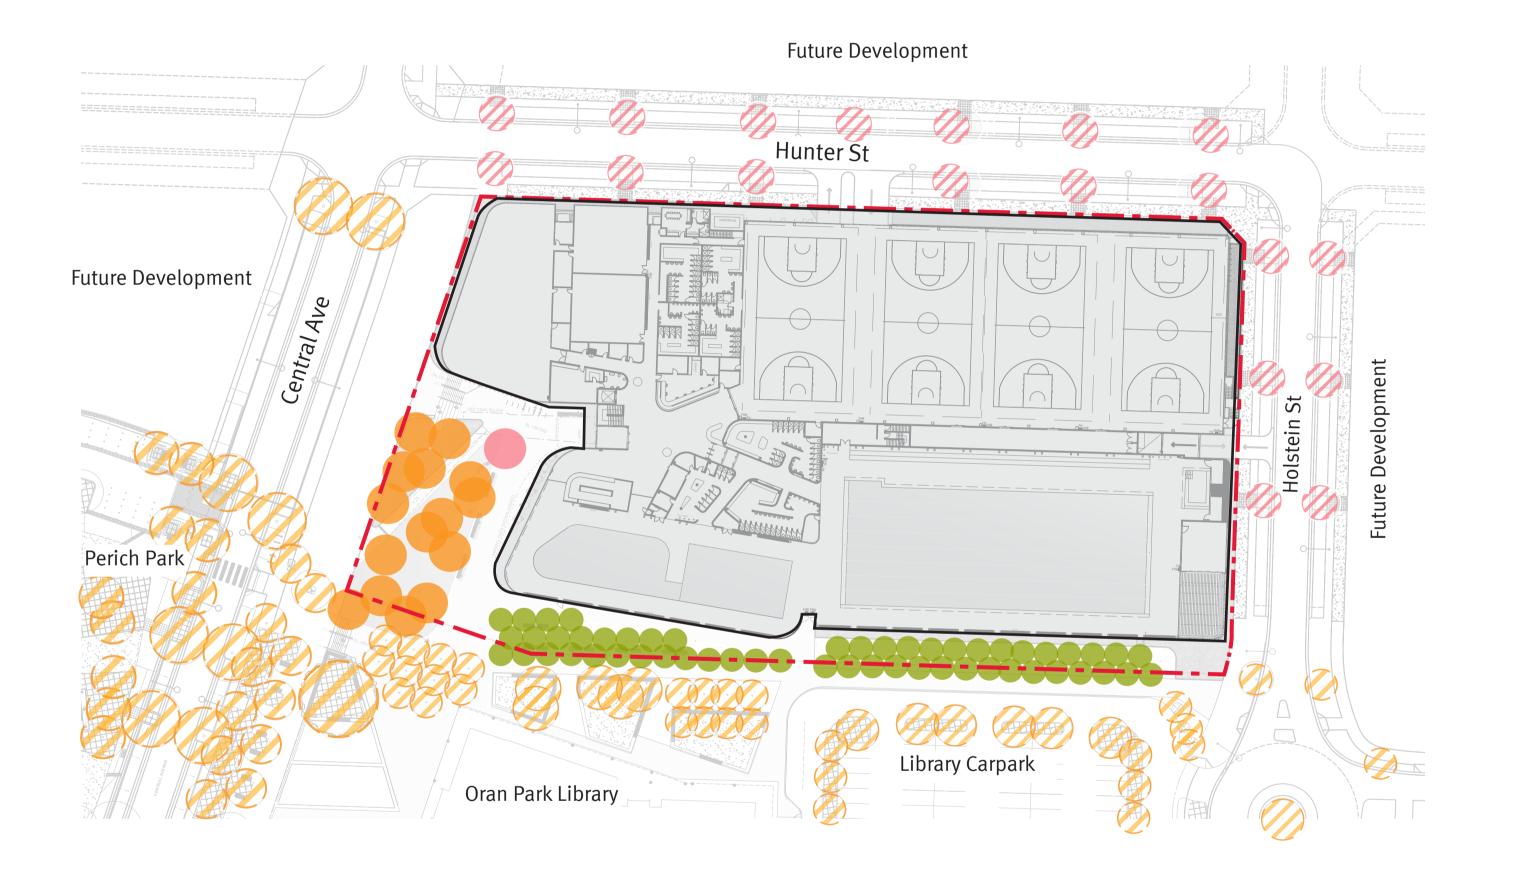

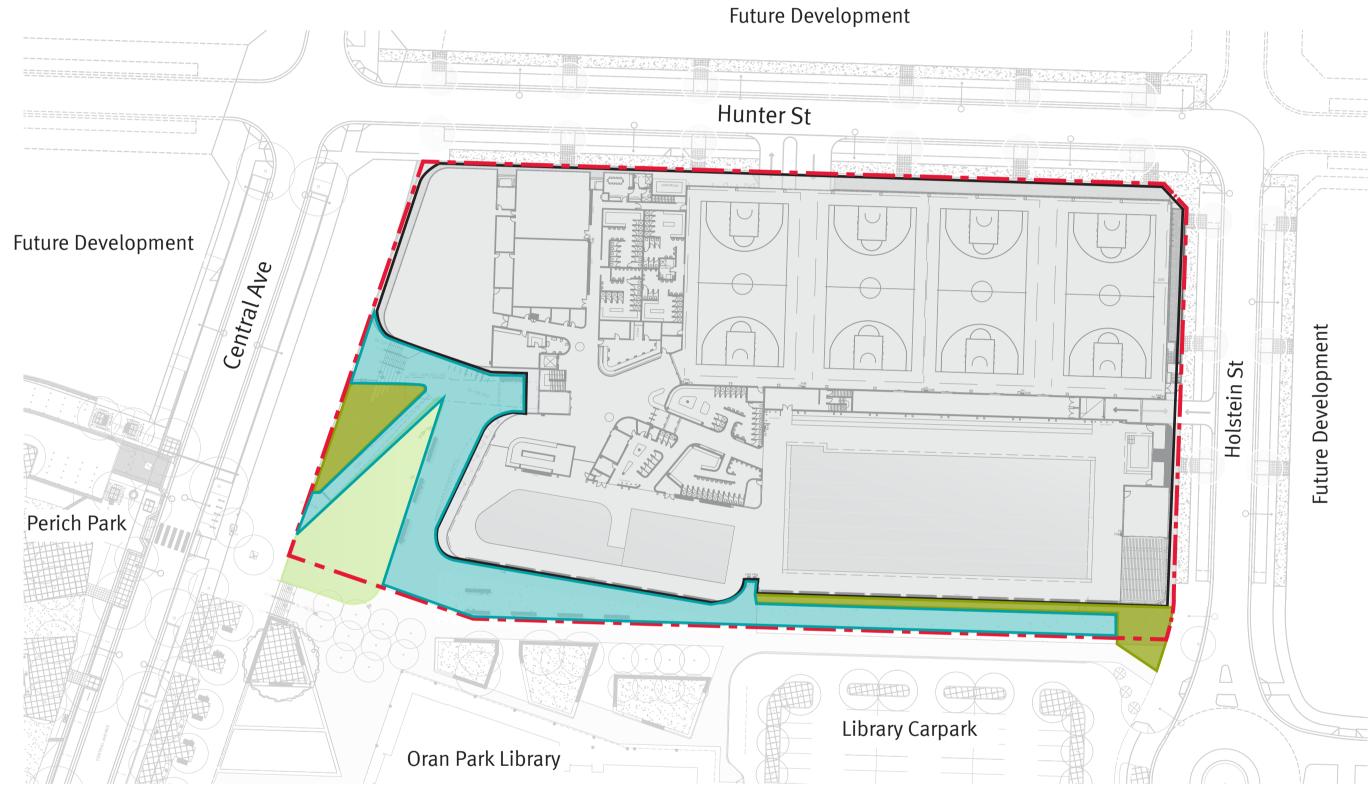




Leisure Centre building

Trees to be delievered as part of Oran Park Leisure Centre

Proposed feature tree - *Ulmus parvifolia* Proposed *Corymbia citriodora* Proposed *Pyrus calleryana* 'Cleveland Select' Trees to other submission



Proposed trees Existing trees

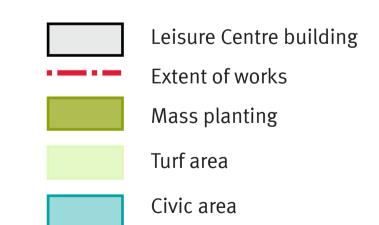

Client

III WARREN AND MAHONEY®

Revisions

Date 23.04.21

Development Application

Check Drawn JM JM







Project Oran Park Leisure Centre Drawing title Design Analysis & Key Principles 02

Date May 2021 Scale Scale NTS

Drawing No. | Issue No. Lo3


Circulation

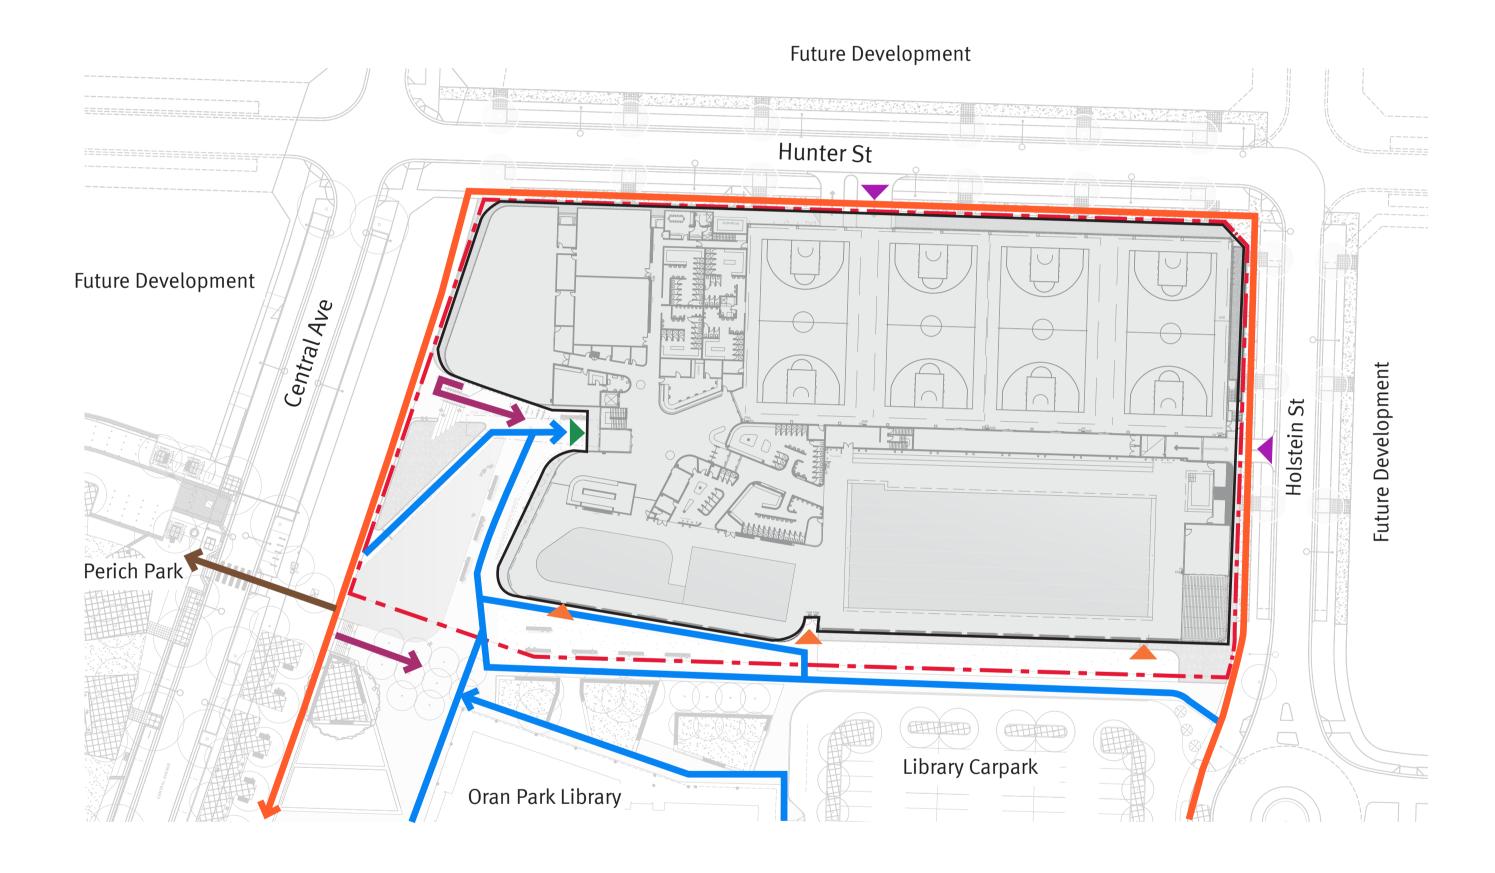

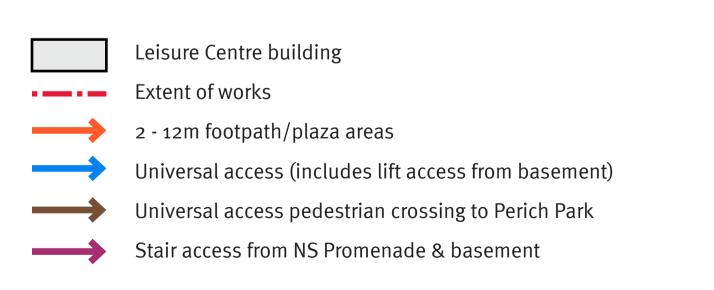

Vehicular access to basement Fire/Emergency/Special Groups Access

Main access to building

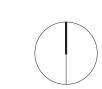


ADV






190 James Street
Redfern NSW 2016
T (02) 9310 5644
info@jmddesign.com.au

Project	Date
Oran Park Leisure Centre	May 2
Drawing title	Scale

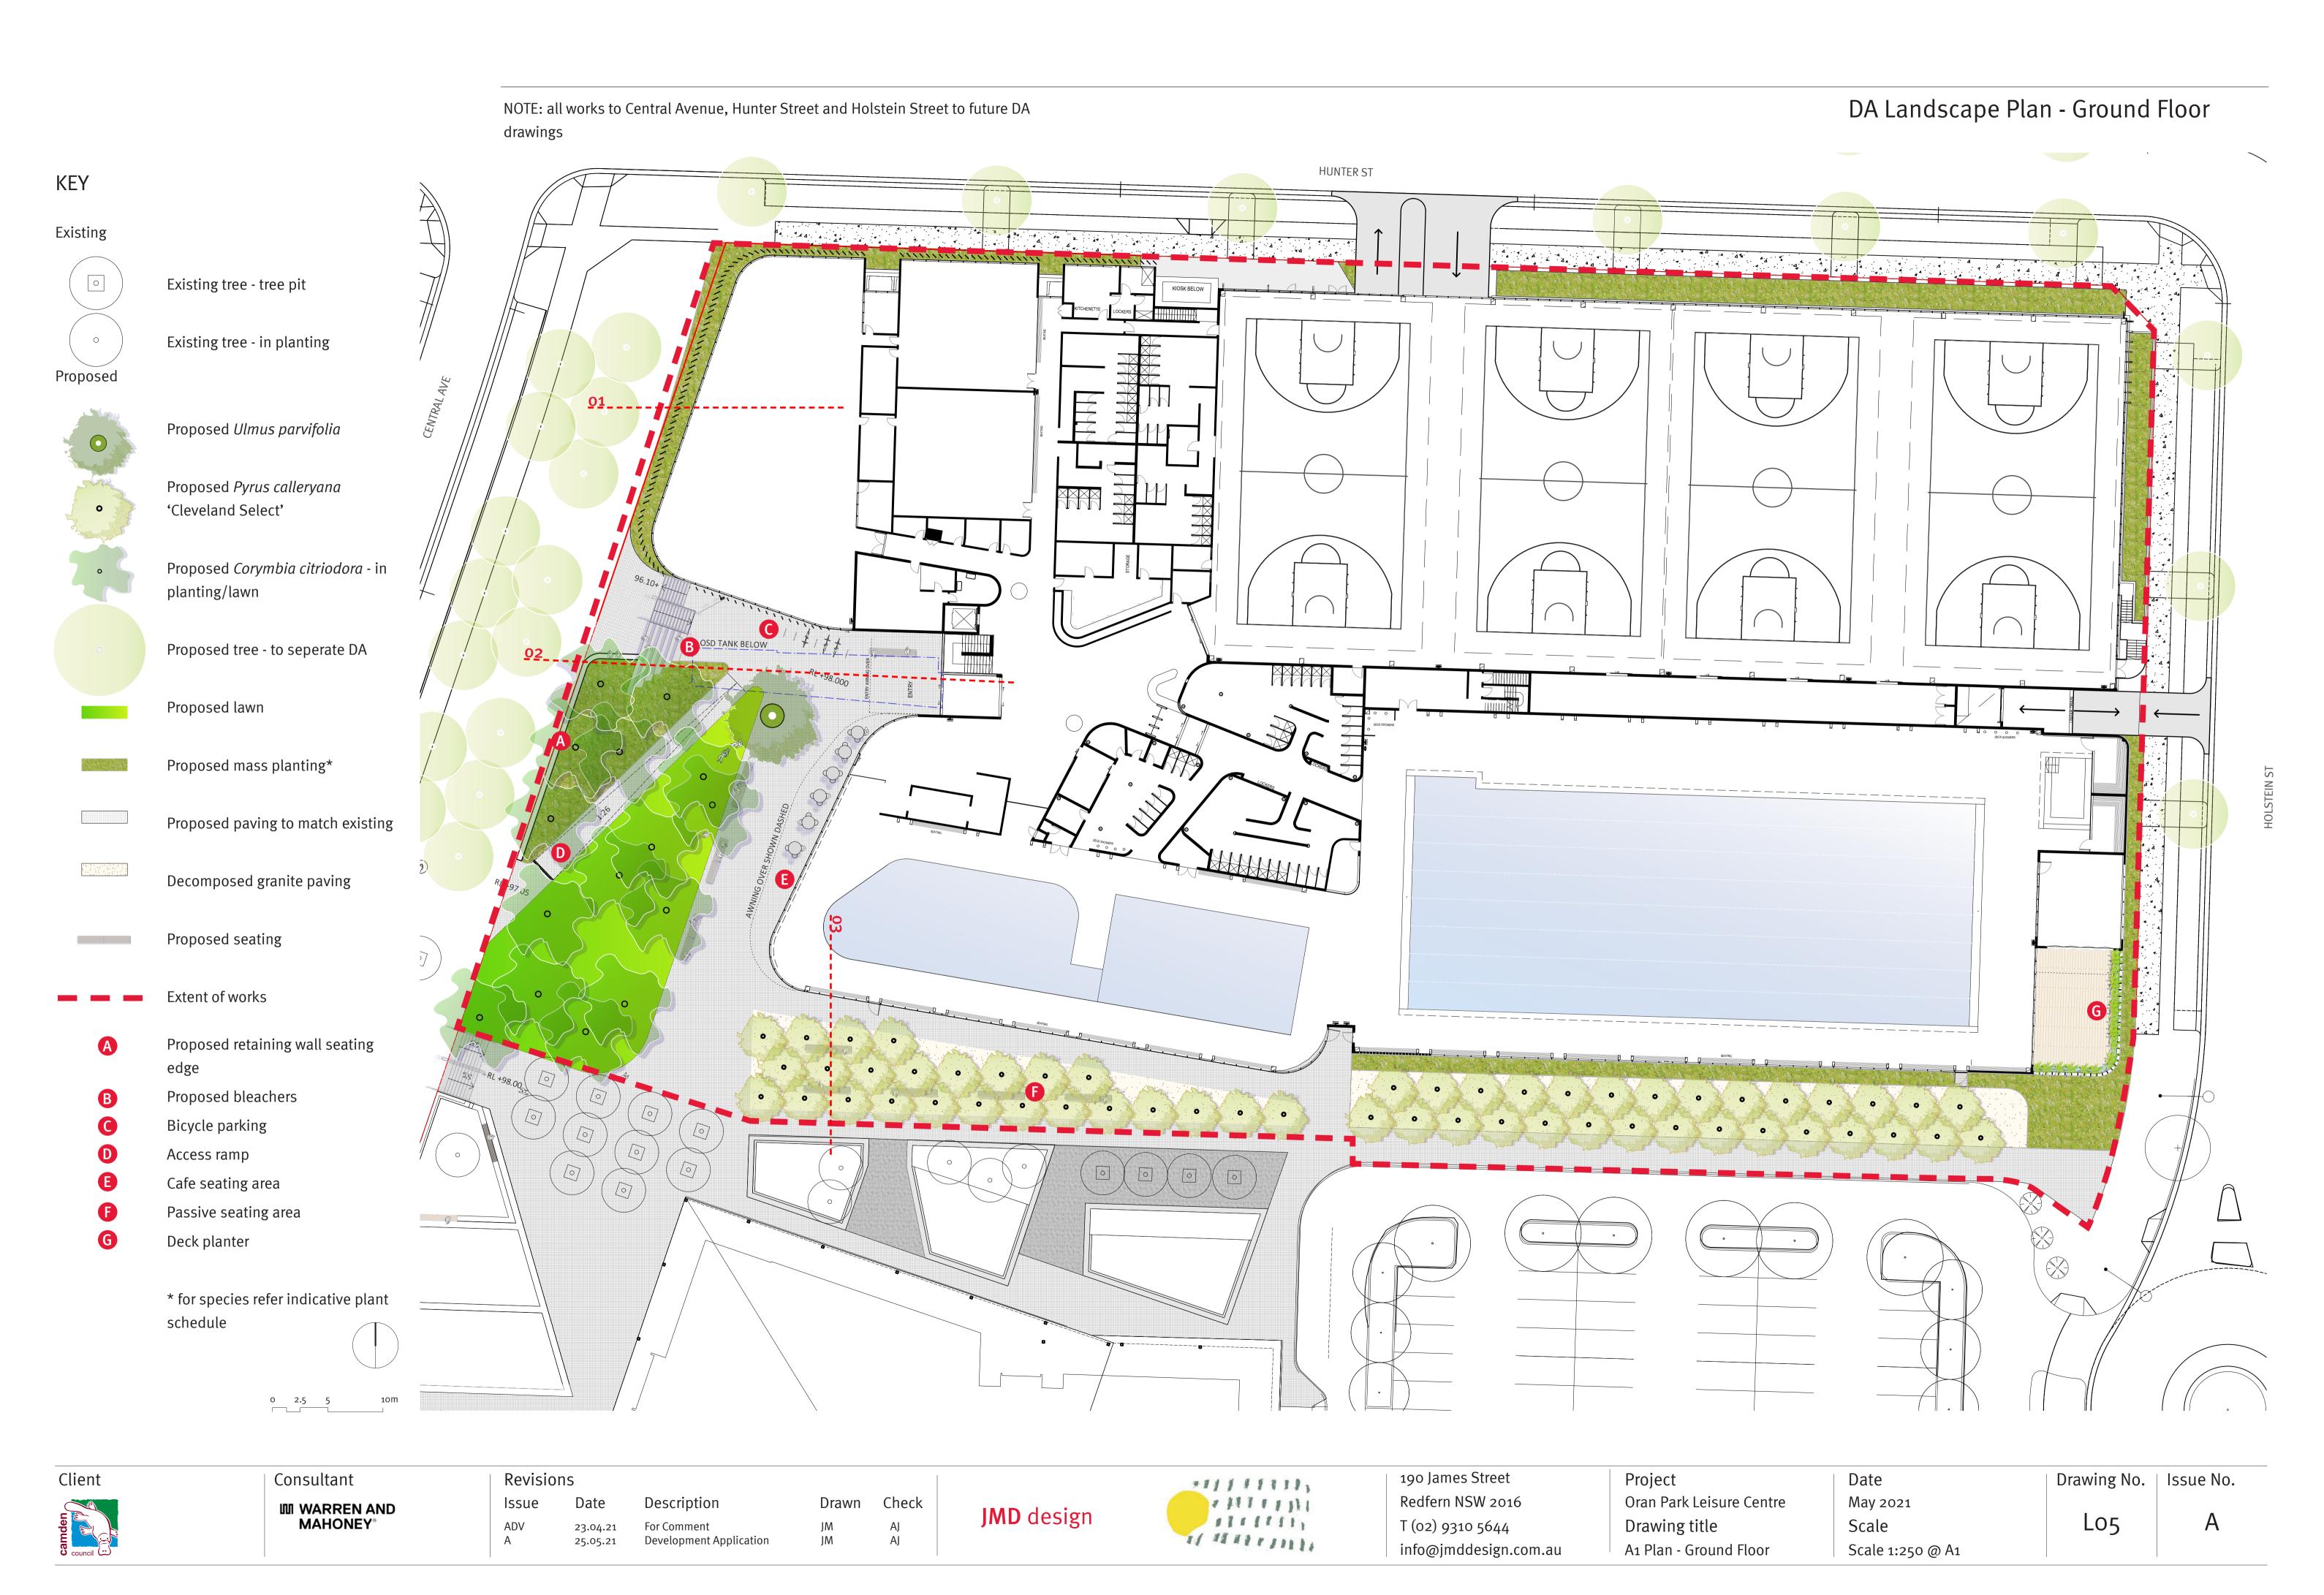

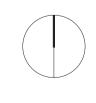

* for species refer indicative

plant schedule

0 2.5 5 10m

Client

KEY

Existing

Proposed mass planting*

Extent of works

Mass planted berm - Max 1:4

Consultant

M WARREN AND
MAHONEY®

Revisions
Issue

ADV

Date Description 23.04.21 For Cor

Description
For Comment
Development Application

Drawn Check

JM JM





190 James Street
Redfern NSW 2016
T (02) 9310 5644
info@jmddesign.com.au

Project
Oran Park Leisure Centre
Drawing title
A1 Plan - Lower Ground

Date
May 2021
Scale
Scale 1:250 @ A1


Drawing No. Issue No.


Lo6


A

Sectional Elevations

Sectional Elevation 01

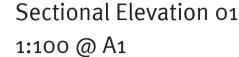

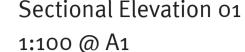

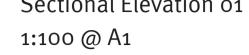






Central


▼ 94.6 L-B1




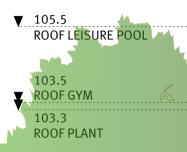


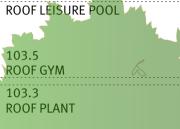

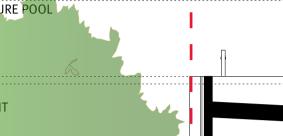

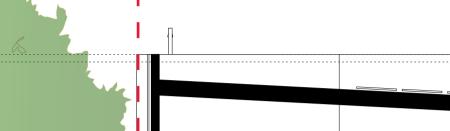


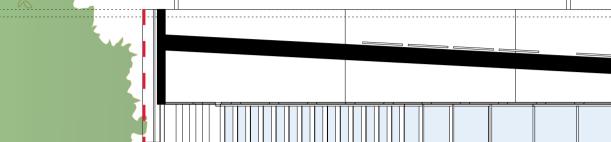

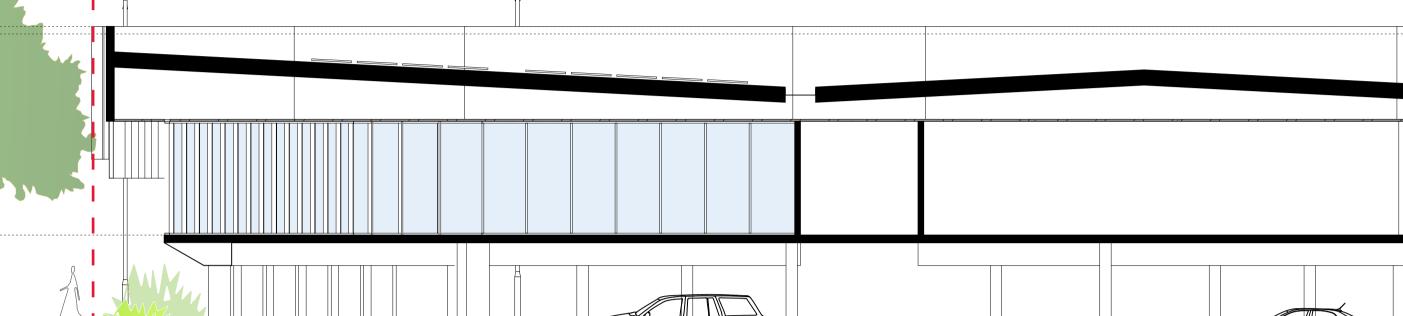


Naturally ventilated carpark



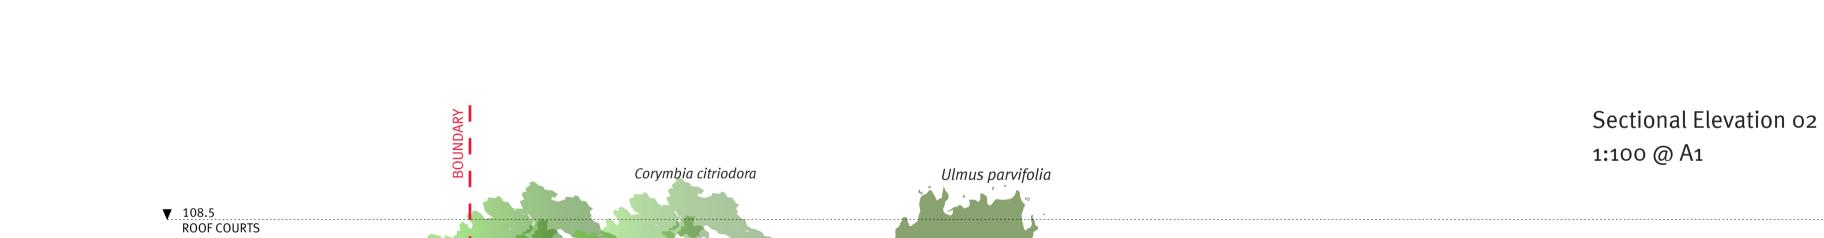




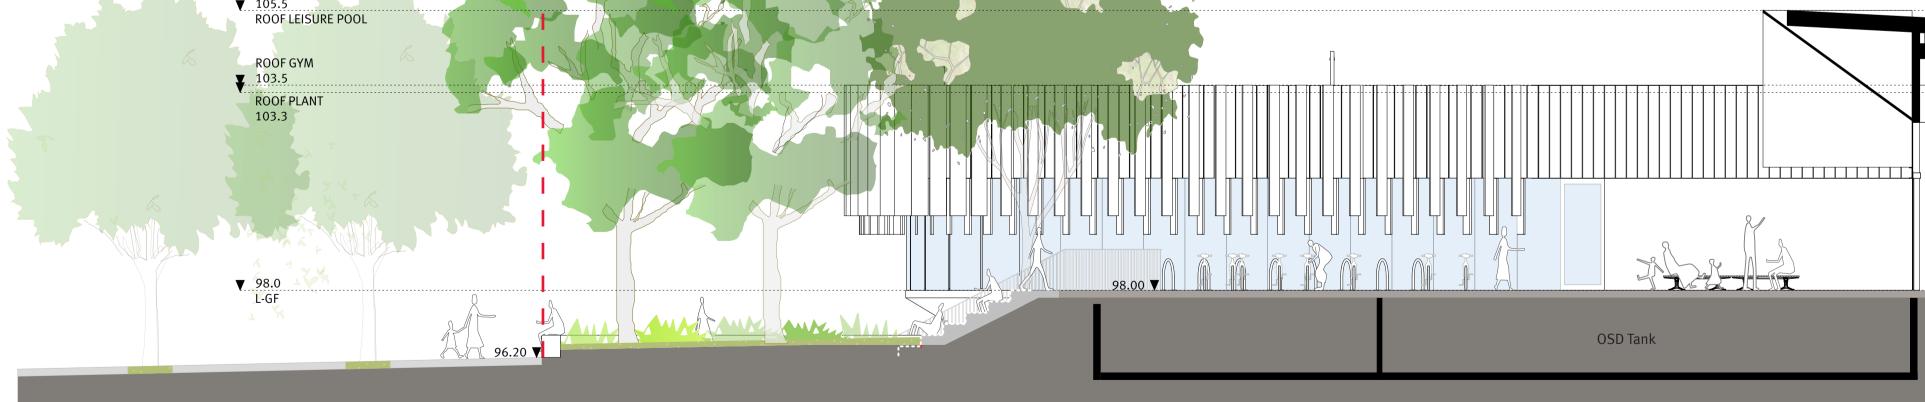

▼ 94.6 L-B1 Work to seperate DA Trees in Mass Stair to Entrance Planting Seating Stairs Bicycle Parking Bicycle Parking Seating Seating Leisure Centre Entrance	7 %	96.20			OSD Tank		
Work to seperate DA Trees in Mass Stair to Entrance Bicycle Parking Seating Leisure Centre Planting & Seating Stairs Entrance	▼ 94.6 L-B1						
Work to seperate DA Trees in Mass Stair to Entrance Bicycle Parking Seating Leisure Centre Planting & Seating Stairs						l	I
	Work to seperate DA	Trees in Mass Planting	Stair to Entrance & Seating Stairs	Bicycle Parking		Seating	Leisure Centre Entrance


Client	

Key plan

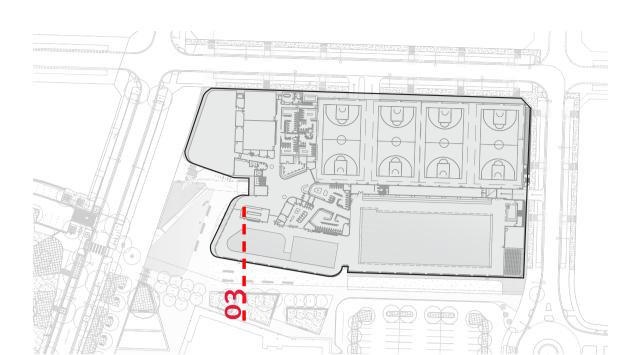

Key plan

Sectional Elevations

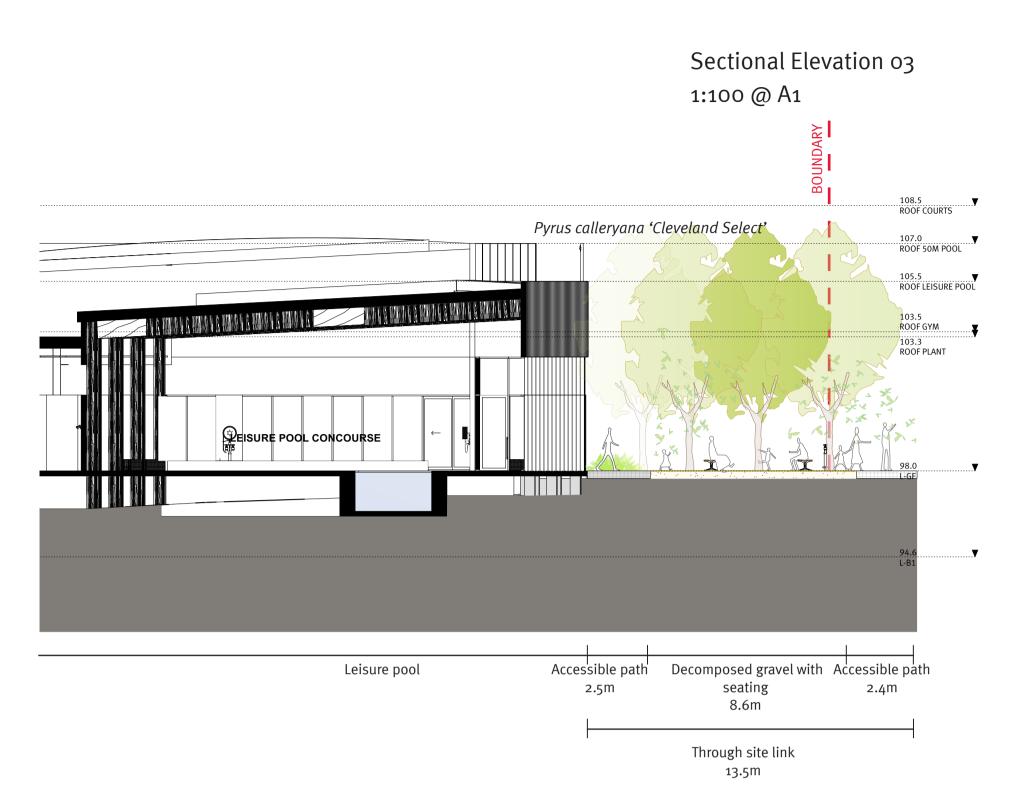





Consultant

Issue **Ⅲ WARREN AND MAHONEY**[®]

ADV A

Revisions Description Date For Comment Development Application 23.04.21 25.05.21

Drawn Check JM JM AJ AJ

JMD design



190 James Street Redfern NSW 2016 T (02) 9310 5644 info@jmddesign.com.au Project Oran Park Leisure Centre Drawing title Sectional Elevations

Date May 2021 Scale Scale 1:100 @ A1

Drawing No. | Issue No. Lo8 A

Planting



Walls & Edges



In-situ and/ or precast concrete walls and retaining edges

Materials & Finishes Palette






Trees



Pavements



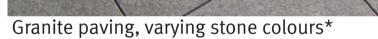




Decomposed granite paving



Indicative Materials Palette

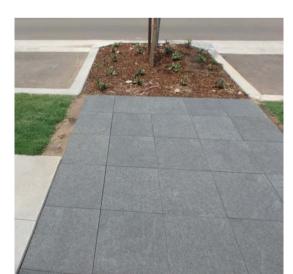

Granite paving Type B



Paving Type F -'CCH Gost Gum' lightly washed

coloured concrete

Revisions

'Raven Black' with exfoliated



Dish drain

Standard Furniture - OPTC Materials & Furniture Suite



Steel bicycle racks (subsurface fixed)



Powdercoated metal rubbish bin enclosure*





Metal and hardwood timber batten benches and seats as standard seating type

Street furniture to future detail consistent to Town Park and North South Promenade

* Refer to Oran Park Town - Public Domain Manual, 2011

Client Consultant



III WARREN AND MAHONEY®

ADV 23.04.21

Description For Comment

Development Application

JMD design



190 James Street Redfern NSW 2016 T (02) 9310 5644 info@jmddesign.com.au

Project Oran Park Leisure Centre Drawing title Materials and Finishes Palette

Date May 2021 Scale

Drawing No. | Issue No.

Lo9

Indicative Plant Schedule

Trees

Mass Planting -Shrubs





Corymbia citriodora





Dianella spp.



Juniperus conferta







Dichondra repens





P. calleryana 'Cleveland Select'



R. indica 'Snow Maiden'



Ficinia nodosa



L. longifolia 'Tanika'





Syzygium australe 'Tiny Trev'



Gazania tomentosa



L. Longifolia 'Verday'



Ulmus parvifolia



Westringia fruticosa 'Grey Box'



Hardenbergia 'Happy Wanderer'





Viola hederacea



Botanical name Height Common name Pot size **Trees:** Corymbia citriodora Lemon Scented Gum 100L 30m Pyrus calleryana 'Cleveland Select' Ornamental Pear 100L 10M Ulmus parvifolia Chinese Elm 100L 13M

Mass Planting - Shrubs:

Grevillea 'Mt Tamboritha'	Grevillea	Varies	140mm pot
Philotheca buxifolia	Box Leaf Wax Flower	1 M	140mm pot
Westringia fruticosa 'Grey Box'	Dwarf Coastal Rosemary	600mm	140mm pot
Westringia fruticosa 'Zena'	Coastal Rosemary	600mm	140mm pot

Grasses & Groundcovers

Dianella spp.	Blue Flax Lily	Varies	90x90x50mm
Dichondra repens	Kidney Weed	100mm	90x90x50mm
Ficinia nodosa	Knobby Club Rush	Varies	90x90x50mm
Lomandra longifolia 'Tanika'	Tanika Mat Rush	600mm	140mm pot
Viola hederacea	Native Violet	100mm	90x90x50mm

Mass Planting Species - Ornamental

Hardenbergia 'Happy Wanderer'	False Sarsaparilla	Varies	200mm po
Rhaphiolepis indica 'Snow Maiden'	Indian Hawthorn	6oomm	140mm pot
Syzygium australe 'Tiny Trev'	Lilly Pilly	1m	140mm pot

Ornamental Grasses, Groundcovers & Climbers

Gazania tomentosa	Gazania	300mm	140mm pot
Juniperus conferta	Shore juniper	500mm	140mm pot
Liriope 'Just Right'	Lilyturfs	500mm	140mm pot
Lomandra 'Verday'	Dwarf Lomandra	600mm	140mm pot
Trachelospermum 'Tri Colour'	Star Jasmine	300mm	140mm pot

Deck Planter

Alpinia nutans **Dwarf Cardamon** 140mm pot 1500mm Rhapis excelsa Rhapis Palm 3000mm 140mm pot

Deck Planter



Alpinia nutans



Rhapis Excelsa

-Indicative heights at maturity.

Client

Consultant

Ⅲ WARREN AND MAHONEY®

Revisions Issue

ADV

23.04.21

Description For Comment **Development Application**

Check Drawn AJ AJ

JM JM

JMD design



190 James Street Redfern NSW 2016 T (02) 9310 5644 info@jmddesign.com.au

Project Oran Park Leisure Centre Drawing title Indicative Plant Schedule

Date May 2021 Scale NA

Drawing No. | Issue No. L10

⁻Indicative planting palette only - subject to availability and confirmation during procurement.